A NEW CUSTOM RESIDENCE FOR

ANTHONY & VICKI SKIDMORE

608 Bayview Drive | Longboat Key, Florida | 34228 Manatee County







AUG 2 0 2021

APPROVED



00

GENERAL NOTES

- DEAWRIGS: DO NOI SCALE HEES DRAWNIGS. WITTEN DIMENSIONS AND NOITE SHALL CONTROL.
 CONTACT HE SUPERNITEDIST WITH ANY CONFLICTS IN THE PLANS BEFORE EGONNING WORK. UNIESS
 OTHERWISE SPECEP, ALL DIMENSIONS ARE TO STRUCTURAL IEEE AND SOOT INCLUDE FIRSTED.
 DIMENSIONS, SIZES, MEASUREMENTS AND LOCATION INSTRUCTIONS ARE NOWMAL AND APPROXIMATE AND
 DIMENSIONS, SIZES, MEASUREMENTS AND LOCATION INSTRUCTIONS ARE NOWMAL AND APPROXIMATE AND
 DIMENSIONS, SIZES, MEASUREMENTS AND LOCATIONS SHALL REPORT SEPONSIBILITY OF THE PLANS AND LOCATIONS AND LOCATIONS OF THE PLANS AND LOCATIONS OF THE PLANS AND LOCATIONS OF THE PLANS AND LOCATIONS AND RESIDENTIFY COUNTY, SIZE AND PEPERAL COURS. CONTINUED AND APPEARANCE TO PLANS AND AND LOCATIONS AND RESIDENTIFY COUNTY, SIZE AND PEPERAL COURS. CONTINUED AND APPEARANCE TO PLANS AND AND LOCATIONS AND RESIDENTIFY COUNTY, SIZE AND SOUTH PEPERAL COURS. COUNTING AND APPEARANCE AND SHALL PROPERATIONS. AND SHALL PROPERATIONS AND PERSONS AND LOCATIONS AND APPEARANCE AND SHALL PROPERATIONS. AND SHALL PROPERATIONS AND PERSONS AND APPEARANCE AND SHALL PROPERATIONS. AND SHALL PROPERATIONS AND PERSONS A

- EQUIPMENT DRAWINGS: CONTAINED HEREIN ARE FOR SCHEMATIC LAYOUT ONLY, AS SUCH ALL DIMENSIONS AND LOCATIONS ARE APPROXIMATE. CABRIETS ARE 108 BUILT AND INSTALLED PER APPROVED CABRIET DRAWING AS SUPPORTED BY CONTRACT DOCUMENTATION.

DESIGN DISCLOSURE THE PURPOSE OF THIS DISCLOSURE IS TO ACKNOWLEDGE THAT JOHN CANNON HOMES, INC. DESIGNS BUILDING

REPRESENTING ITSELF AS AN ARCHITECT OR EXPERT IN THE FUNCTIONAL UTILITY OF HOUSE DESIGN, IN ASSUCH, TO NO EPRESENTATIONS ARE MADE AS TO THE ASSTRETCH SET INFORMATION OF THE PLANT OF THE ASSTRETCH AS TO THE OWNER OF THE PLANT O TING ITSELF AS AN ARCHITECT OR EXPERT IN THE FUNCTIONAL UTILITY OF HOUSE DESIGN. IN AS SUCH

OBTAINING THIS ASSISTANCE ARE THE SOLE RESPONSIBILITY OF THE CUSTOMER, AND ADDITIONAL COSTS COULD OBTAINING THE ASSISTANCE ARE THE SOLE REPROSBBILITY OF THE CUSTOMER, AND ADDITIONAL COSTS COULD BE INCUREDED SHOULD CHANGES TO THE BUILDING PLANS REFIGURED. PURITHERMORE, THESE THANAS ARE A GRAPHIC REPRESENTATION OF THE PRELIMINARY DESIGN OF A HOUSE, ACTUAL PLACTEMENT OF THE HOUSE ON THE LOT, ROOM SEEK, WINDOW SEEK AND PLACEMENT, DOOR SIERS AND SHOW THE PROBLEMENT (CARTIONS AND OTHER FIRST WATCH CARTIONS AND OTHER PROBLEMENTS, AND STRUCTURAL REQUIREMENTS AFTER ENGINEERING.

EROSION & SEDIMENT CONTROL NOTES

- WHEN RANFALL AND RUNOIF OCCURS, DAILY INSPECTIONS OF THE EROSION AND SEDIMENT CONTROLS AND DSCHARGE OUTFALLS MUST BE PROVIDED BY SOMEONE KNOWLEDGEABLE AND DEPERBINCED IN THE PRINCIPLES, PRACTICES, INSTALLATION, AND MANTENANCE OF EROSION AND SEDIMENT CONTROLS WHO WORKS FOR THE PREMITTEE, DURING WET WEATHER PERIOD, TEMPORARY STABLUATION OF THE STE MUST OCCUR AT THE END OF EACH WORK DAY, SEDIMENT CONTROLS MUST BE INSTALLD AND MANTANEAU ON ALL DOWN GRADIENT SIZES OF THE CONSTRUCTION SITE AT ALL THIS DURING CONSTRUCTION, THEY MUST REMAIN IN PLACE TRUTH EPRIMARBHY WEGGETATION OR OTHER PERMANENT COVENING OF EXPORTS DOIL IS STANKED.
- COVERING OF EXPOSED SOIL IS ESTABLISHED. ALL ACTIVE INLETS MUST HAVE SEDIMENT CONTROLS INSTALLED AND MAINTAINED AT ALL TIMES DURING CONSTRUCTION. UNLESS OTHERWISE APPROVED, A SURFACE MOUNTED AND ATTACHABLE, U-SHAPED FILTER BAG IS REQUIRED FOR ALL CURB
- INCEL CALCH BASINS. SIGNIFICANT AMOUNTS OF SEDIMENT WHICH LEAVES THE SITE MUST BE CLEANED UP WITHIN 24 HOURS AND PLACED BACK ON

- SIGNIFICANT AMOUNTS OF SEDIMENT WHICH LEAVES THE SITE MIST BE CLEANED UP WITHIN 22 HOURS AND PLACED BACK OF HIE SIE AND STREETED OF REPORTED PROSCRED. THE CAUSE OF THE SEDIMENT RECEASE MUST BE CHURCH AND PROVIDED THE SITE AND STREET OF THE STREET OF THE SECRET MUST BE COME. THE STREET OF THE ST
- RECOMMENDATIONS, NUTRIENT RELEASES FROM FERTILIZERS TO SURFACE WATERS MUST BE MINIMIZED. TIME RELEASE FERTILIZERS SHOULD BE USED AND CARE SHOULD BE MADE IN APPLICATION OF FERTILIZERS WITHIN ANY WATER WAY RIPARIAN
- ZONE.

 OWNER OR DESIGNATED PERSON SHALL BE RESPONSIBLE FOR PROPER INSTALLATION AND MAINTENANCE OF ALL EROSION AND SEDIMENT CONTROL MEASURES IN ACCORDANCE WITH CURRENT CLEAN WATER SERVICES STANDARDS, STATE, AND TECHNICAL CONTROL MEASURES IN ACCORDANGE OF THE CLEAN UNITE. WITE CHARLES OF THE CLEAN UNITE. STATE OF THE RED. UNITES OF CHERWIS A PROPOSED, NO DESTURBANCE SE PREMITED BETOR BHE CLEANS OF UNITE. THE WITE PROPOSED UNITES OF CHARLES OF THE WATER OF THE RED. UNITES OF THE WATER OF THE RED. UNITES OF THE WATER OF THE RED. UNITES OF THE WATER OF THE WATE
- PRIOR TO ANY LAND DISTURBING ACTIVITIES, THE BMPS THAT MUST BE INSTALLED INCLUDE; GRAVEL CONSTRUCTION ENTRANCE, PERIMETER SEDIMENT CONTROL, AND INLET PROTECTION. THESE BMPS MUST BE MAINTAINED FOR THE DURATION.
- F THE PROJECT.

 VEGETATIVE SEED MIXES ARE SPECIFIED, SEEDING MUST TAKE PLACE NO LATER THAN SEPTEMBER 1ST; THE TYPE AND

- IS PYCEGATIVE SED MIKES ARE SPECIFED. SEEDING MUST TAKE PIACE NO LAIRE HAM SEPTEMBER 11ST THE 17PE AND PERCENTIAGES OF SEEDIN HIS MER ARE AS IDENTIFIED ON THE PIACH OR AS SPECIFIED BY THE DESIGN HORDINES.

 ALL PUMPING OF SEDIMENT LODEN WATER MUST BE DECHARGED OVER AN UNDSTURBED, PREFERABLY VECEPATED AREA, AND INSCIDINES SEDIMENT CORNER. DAVIE 12 FLETS HAVE AND THE PIACH MUST BE HIS MILED POPERIS IT OF BUSINESS. THE SEDIMENT LADDEN WATER DOES NOT ENTIFE A MUST BE HAST LED POPERIS IT OF BUSINESS. THE SEDIMENT LADDEN WATER DOES NOT ENTIFE A SUBFACE WATER SYSTEM. ROADWAY, OR OTHER PROPERTIES. THE SEDIMENT LADDEN WATER DOES NOT ENTIFE A MUST AND THE MUST BE AND THE MUST BE CONDITIONS. DURING THE CONSTRUCTION PERSON, THESE MARASHES SHAUL BE UPGRADED AS NEEDED TO MAINTAIN COMPULANCE WITH ALL REGULATIONS.

 IN AREAS SUBJECT ON WIND EROSION, APPROPRIATE BMPS MUST BE USED WHICH MAY INCLUDE THE APPLICATION OF FINE WATER SYSTEMATION.

TYPICAL ABBREVIATIONS

ADDITIONAL ABBREVIATI	ONS A	ND SYMBOLS CAN BE FI	V DAUC	VITHIN THE RELEVANT SH	EET'S LE	GEND AND/OR NOTES.
ABOVE	CP	CROWN PERIMETER	НВ	HOSE BIBB	REF	REFRIGERATOR
ABOVE FINISHED FLOOR	DFE	DESIGN FLOOD ELEVATION	LAV	LAVATORY	SGD	SUDING GLASS DOOR
AIR HANDLER UNIT	DC	DISAPPEARING CORNER	MFG	MANUFACTURER	SF	SQUARE FEET (FOOT)
ALUMINUM	0.69	DISPOSAL	MAX	MAXIMUM	51	SQUARE INCH(ES)
ARCHITECTURAL	DIST	DISTANCE	MECH	MECHANICAL	SHWR	SHOWER
BASE FLOOD ELEVATION	ELEC	ELECTRICAL	MIN	MINIMUM	SH	SINGLE HUNG WINDOW
BUILDING	ELEV	ELEVATION	MIR	MIRROR	SPECS	SPECIFICATIONS
CABINET	ENG	ENGINEER	NAVD	NORTH AMERICAN	STRUCT	STRUCTURAL
CALCULATION(S)	EQUIP	EQUIPMENT		VERTICAL DATUM	T&G	TONGUE AND GROOVE
CASEMENT WINDOW	FF	FINISHED FLOOR	NGVD	NATIONAL GEODETIC	TYP	TYPICAL
CONTRACT ITEMIZATION	FG	FIXED GLASS		VERTICAL DATUM	UC	UNDER COUNTER
CUSTOMER ACCOMMODATION	N FLR	FLOOR	oc	ON CENTER	VEST	VESTBULE
CBLING	FR DR	FRENCH DOOR	OHD	OVERHEAD DOOR	WC	WATER CLOSET
CONCRETE MASONRY UNIT	HDR	HEADER	PKT	POCKET DOOR	WH	WATER HEATER
CONCRETE	HVAC	HEAT & AIR CONDITIONING	RA	ROOM AREA	WIC	WALK IN CLOSET
	ABOVE ABOVE FINSHED PLOOP ARE HANDLIR LINE AUMANIM ACCHIETCIDEAL BASE RICOD ELEVATION BUILDING CARRIET CARRIET CASTANTI WINDOW CONTRACT IERUILITION CUSTOMER ACCOMMODATION CUSTOMER ACC	ABOVE CONTROL OF CONTROL OT CONTROL OF CONTROL OT CONTR	ACON PROMISE TO CONVERSAME AND PROMISE TO CONTROL TO THE CONTROL	ADOVE OF CONNETRIBUTES 15 ADOVERNMENT NO. 07 CROWN FROM 15 ADDVENT NO. 07 CR	ACOUNT A	MOVEMBER DECORPORT DESCRIPTION LEV CANADER SECONDARIA MARKAGER MA

DESIGN CRITERIA

R	EA CALCULATIONS				BUILDING CODE
	BUILDING AREAS				2020 Florida Building Code, 7th Edition
	GROUND LEVEL FOYER	288	SQ FT		2017 National Electric Code
	MAIN LIVING LEVEL	1,757	SQ FT		PROJECT SPECIFIC INFORMATION
	SECOND LIVING LEVEL	1,371	SQ FT		PARCEL ID: 7860800007
	TOTAL LIVING(UNDER A/C)	3,416	SQ FT		JURISDICTION: LONGBOAT KEY (MANATEE COUNTY)
	ENTRY	59	SQ FT		ZONING: R-4SF
	LOWER LANAI	959	SQ FT	CI-344	FEMA FLOOD ZONE: AE
	GARAGE / STORAGE	1,373	SQ FT	CI-343	BASE FLOOD ELEVATION: 9'-0" NAVD
	MAIN LIVING BALCONY	47	SQ FI		DESIGN FLOOD ELEVATION: 10'-0" NAVD
	MAIN LANAI	708	SQFT	CI-346	LOT SIZE: 10,000 +/- SF
	UPPER BALCONY	47	SQ FT		ALLOWABLE LOT COVERAGE: 30% (3,000 SF)
	UPPER LANAI	159	SQ FT	CI-347	ACTUAL LOT COVERAGE: 28% (2,840 SF)
	MECHANICAL EQUIP. ELEVATED SLABS	162	SQ FT	-3	ALLOWABLE IMPERVIOUS LOT COVERAGE: 50% (5,000 SF)
	TOTAL UNDER ROOF	3,514	SQFF		ACTUAL IMPERVIOUS LOT COVERAGE: 48% (4,818 SF)
	POOL DECK	703	SQ FT	CI-345	······································
	DRIVEWAY	1,275	SQFF		

DRAWING SHEET INDEX SITE AND DRAINAGE PLAN

GROUND LEVEL FLOOR PLAN GROUND LEVEL DIMENSION PLAN MAIN LEVEL FLOOR PLAN MAIN LEVEL DIMENSION PLAN UPPER LEVEL FLOOR PLAN

A2.0

A2.0d

A2.1c

A2.2

A3.0

A62

A7.0

D1.0

D2.0

A2.2d UPPER LEVEL DIMENSION PLAN ROOF PLAN EXTERIOR ELEVATIONS (FRONT & REAR)

EXTERIOR ELEVATIONS (SIDES) INTERIOR ELEVATIONS

GROUND LEVEL ELECTRICAL PLAN MAIN LEVEL ELECTRICAL PLAN UPPER LEVEL ELECTRICAL PLAN SCHEDULES & NOTES

INTERIOR DETAILS EXTERIOR DETAILS FOUNDATION PLAN FOUNDATION DETAILS

GROUND LEVEL STRUCTURAL PLAN MAIN LEVEL STRUCTURAL PLAN UPPER LEVEL STRUCTURAL PLAN MAIN LEVEL FRAMING PLAN EIVED

LIPPER LEVEL FRAMING PLAN ROOF FRAMING PLAN STRUCTURAL NOTES/SPECS STRUCTURAL DETAILS STRUCTURAL DETAILS

STRUCTURAL DETAILS STRUCTURAL DETAILS

COVER SHEET


SKIDMORE VICKI ∞ ANTHONY



DRAWING TITLE

SHEET NUMBER

A0.0

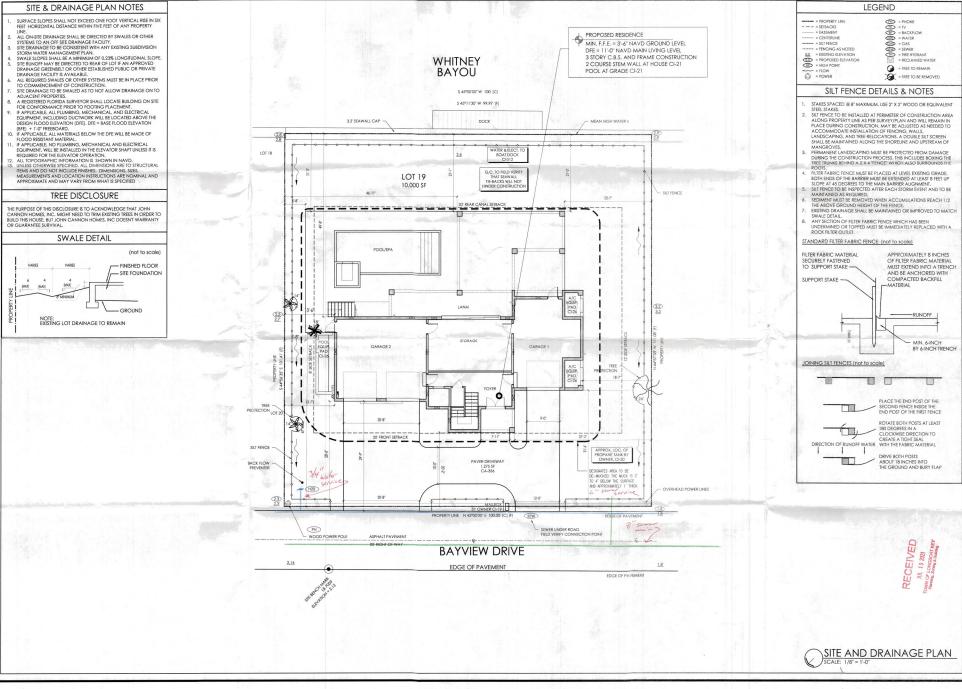

CANNON
CANNON
CANNON
HOLES
Frocestoral Parkway West, Star Es
Sarrison, El 32-0, 412-6
john cannon homes, com

YOUNG FINE FILE FOR STATE OF S

YOUNG HEDRIC

© COPYRIGHT 2021

JOHN CANNON HOMES, INC.
LICKSE ECCAS 1851


The drowing a protected under opplicate
copyright, modernate fight, and/or for other
moder-lang proceedy rights, income use auch or,
shoul finite from the property and proceeding the promised and proceeding the permission of conditions, and professional property and professional processing and proceeding the permission of conditions is permissed without the


A NEW CUSTOM RESIDENCE FOR
ANTHONY & VICKI SKIDMORE
608 Boyview Drive | Longboot Key, Piorido | 34228
107 19 | TOWN OF LONGBOAT KEY | MANATEE COUNTY

SITE AND DRAINAGE PLAN

SHEET NUMBER

A1.0

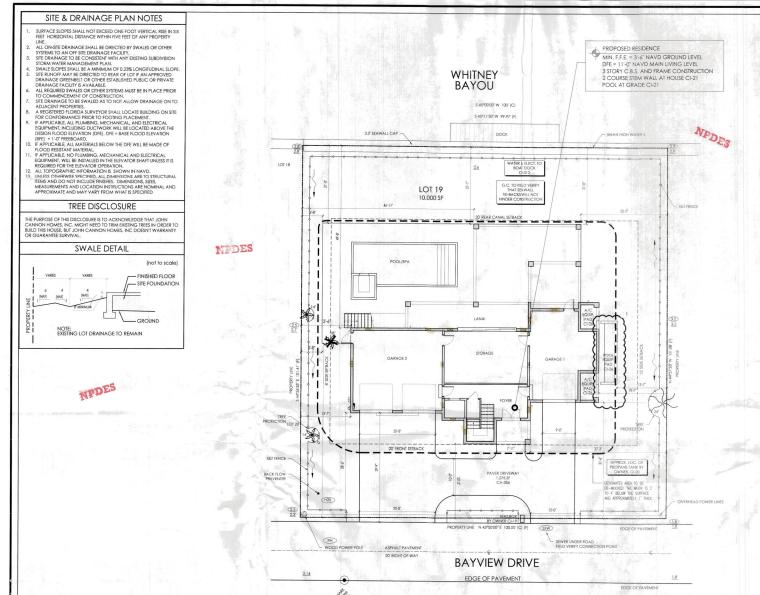

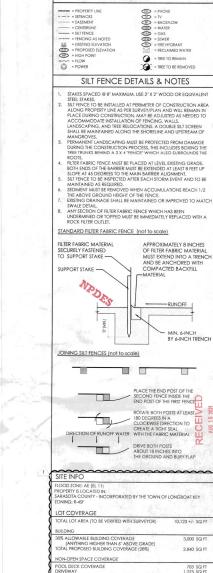

CANN

LEGEND

= PHONE
TD = TV
= TV
= TV
= BACKFLOW
TD = WATER
TD = GAS
TD = SEWER
TD = FIRE HYDRANT
= RECLAIMED WATER

= TREE TO REMAIN

= TREE TO BE REMOVED

APPROXIMATELY 8 INCHES OF FILTER FABRIC MATERIAL

COMPACTED BACKFILL

MUST EXTEND INTO A TRENCH AND BE ANCHORED WITH

-RUNOFF

MIN. 6-INCH BY 6-INCH TRENCH

3,000 SQ I

2,840 SQ FT

703 SQ FT 1,275 SQ FT

5,062 SQ FI

4,818 SQ FT

SECOND FENCE INSIDE THE END POST OF THE FIRST FENCE ROTATE BOTH POSTS AT LEAST

DRIVE BOTH POSTS ABOUT 18 INCHES INTO THE GROUND AND BURY FLAP

YOUNG 圣

SKIDMORE VICKI ∞ŏ ANTHONY

DRAWING TITL SITE AND DRAINAGE


SHEET NUMBER

A1.0

SITE AND DRAINAGE PLAN SCALE: 1/8" = 1'-0"

IMPERVIOUS

NEDIS

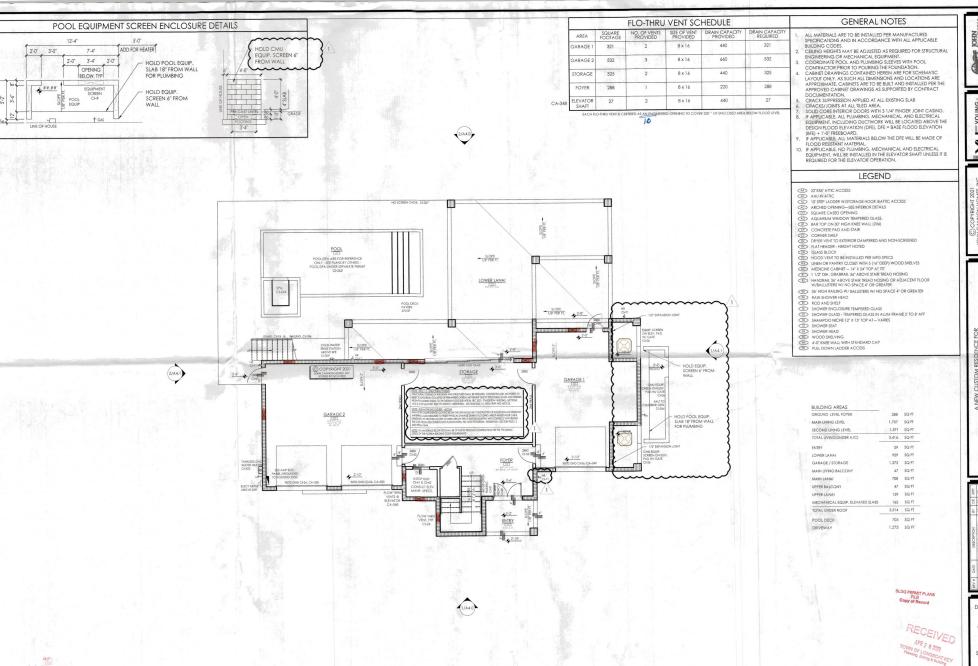

POTENTIAL CANNON CANNON

YH HEDRICK

CANNON HOMES, INC.

LCANNON HOMES, INC.

LCBSE FCCCABSS1

Logical production and report copic co

ANTHONY & VICKI SKIDMORE 608 Boyview Dive I Longboat Key, florida 1 34228 LOT 191 TOWN OF LONGBOAT KEY I MANATEL COUNTY


DRAWING TITLE

Ground Level Floor Plan

SHEET NUMBER

A2.0

GROUND LEVEL FLOOR PLAN

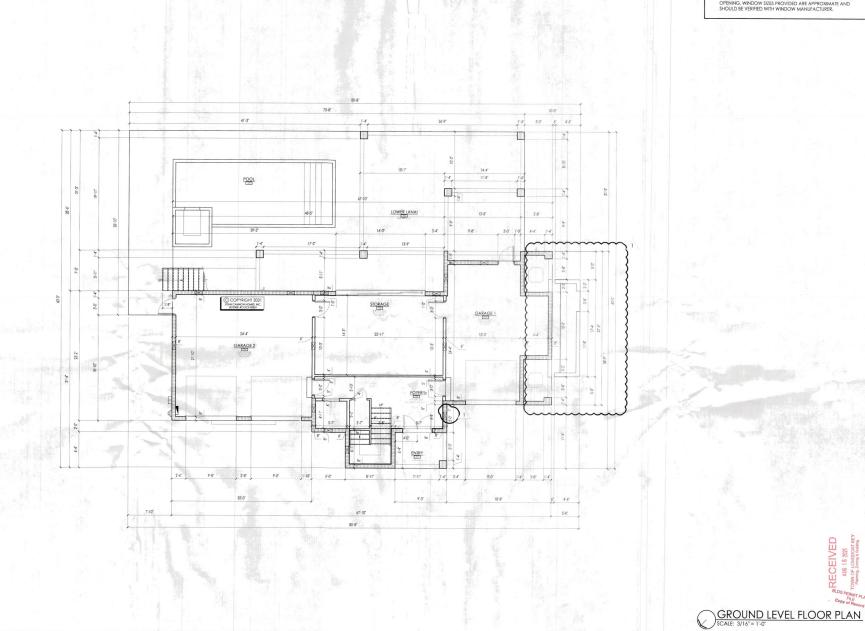

DIMENSION NOTES






ANTHONY & VICKI SKIDMORE 608 BOYNEW DIVE I LONGBOOT REY, Rond a 1 34228 ror 101 nown of I nowadoat Rey. Handan E COUNTY



GROUND LEVEL DIMENSION PLAN

SHEET NUMBER

A2.0d

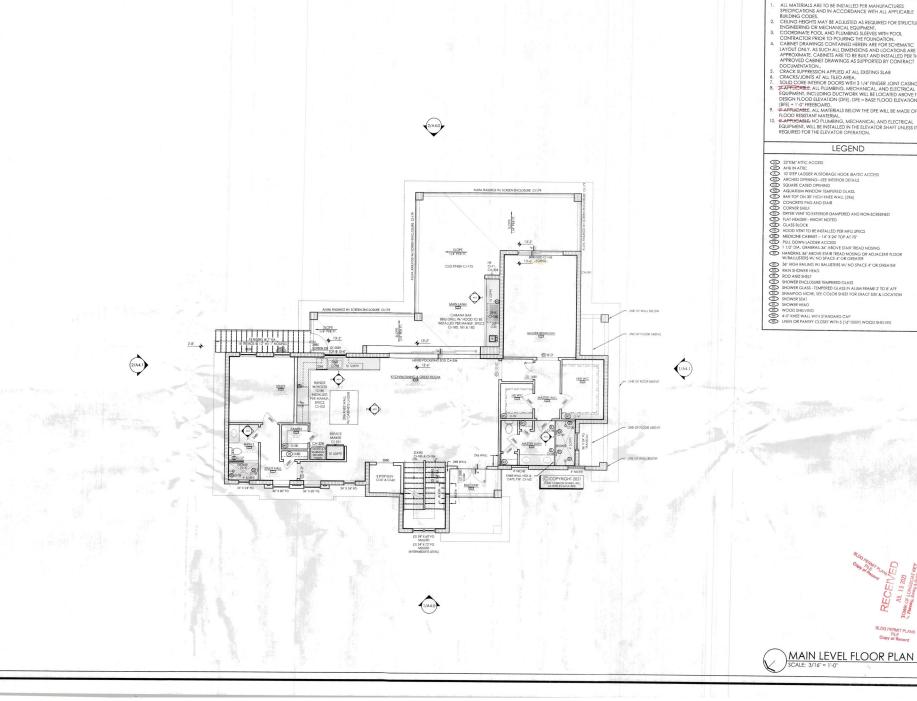

GENERAL NOTES

- GENERAL NOTES

 1. ALL MATERIALS ARE TO BE INSTALLED PER MANUFACTURES SPECIFICATIONS AND IN ACCORDANCE WITH ALL APPLICABLE BUILDING CODES.

 2. CLAUSE HER MAY BE ADJUSTED AS REQUIRED FOR STRUCTURAL CONTRACTOR OF THE ADJUSTED AS REQUIRED FOR STRUCTURAL CONTRACTOR PROFESSOR OF MECHANICAL CEQUIPMENT.

 3. COORDINATE POOL AND FLUMBRIGG SERVES WITH POOL CONTRACTOR PROFE TO POUR MEMBERS ARE TO SERVES WHITH POOL CONTRACTOR PROFE TO POUR MEMBERS ARE TO SERVES WITH AND INSTALLED PER THE APPROXIMATE CANADIST AS SUPPORTED TO CONTRACT OF THE ADDICALMENTATION. CONTRACTOR SUPPORTED TO CONTRACT OF THE ADDICALMENTATION. CONTRACTOR SUPPORTED TO CONTRACT OF THE ADDICALMENTATION. CONTRACTOR SUPPORTED TO CONTRACT OF THE ADDICALMENTATION. SUPPORTED AND ADDICALMENTATION. SUPPORTED THE ADDICALMENT SUPPORTED THE ADDICALMENTATION. SUPPORTED THE ADDICALMENT SUPPORTED THE ADDICALMENT SUPPORTED THE ADDICALMENT SUPPORTED THE ADDICALMENT SUPPORTED THE SUPPORTED

LEGEND







ANTHONY & VICKI SKIDMORE 608 Boyview Dive I Longboat key, Florida I 3428 OT 191 TOWN OF LONGBOAT REY I MANATELE COUNTY




DRAWING TITLE

MAIN LEVEL FLOOR PLAN

SHEET NUMBER

A2.1

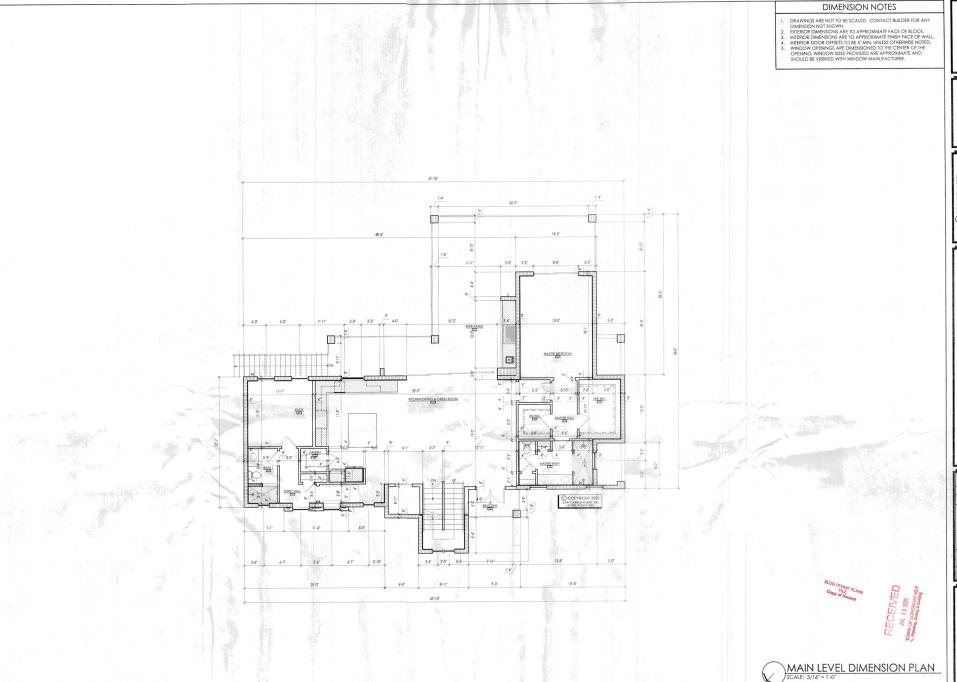





IOHN CANNON HOMES, INC.

LICENER GEORGE ISSU

THE conveying is producted under oppication
or properly in trademore disputation and other
oppication. The conference disputation and other
or production or other conference are such an
old infinition or mending, copying, a depleating
the principle or or conclusions to permitted several or
the conference or or conclusions to permitted several or
the conference or or conclusion or or operation or or or conclusions.

ANTHONY & VICKI SKIDMORE 608 Bayview Dive | Longboat Key, Florida | 34228 LOT 191 TOWN OF LONGBOAT KEY | MANATEL COUNTY


1 100 (100 km) (100 k

DRAWING TITLE

A2.1d - MAIN LEVEL DIMENSION PLAN

SHEET NUMBER

A2.1d

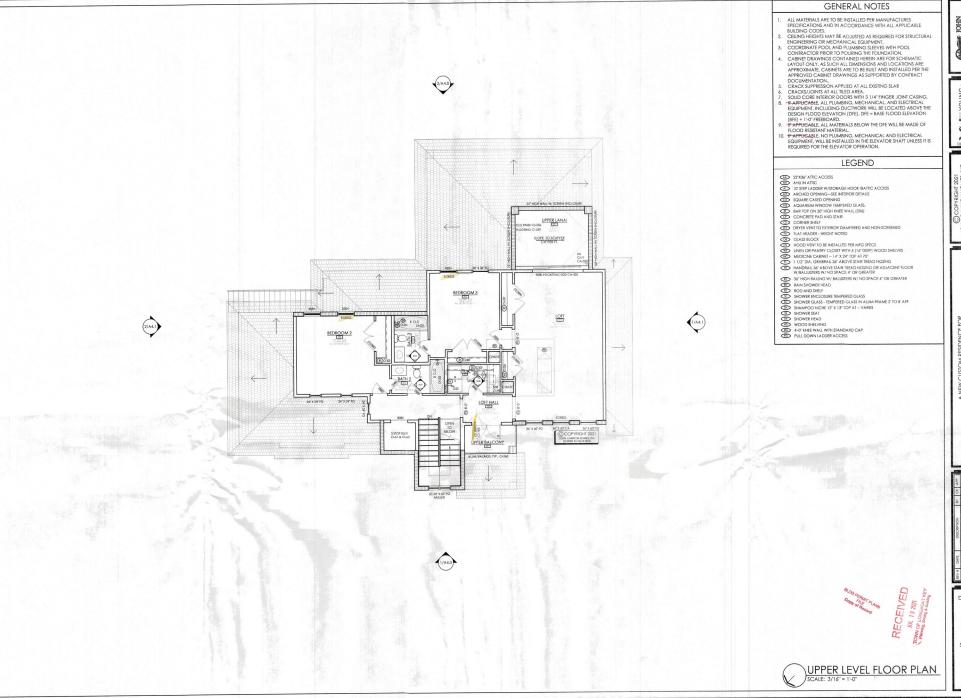

CANNO
CANNO
FORMS
CANNO
FORMS

RICK 6710 Professional Parkwith 18 Sanzasu, FL 3 941.24.24.30.59 P [941.24.24.30.59 P [941.24.30.59 P [94

YOUNG HEDRICK

(C) COPYRIGHT 2021
JOHN CANNON HOMES, INC.
LICENSE ECCCA1853.
This devotes the conference of the confe


ANTHONY & VICKI SKIDMORE 408 Boyview Drive I Longboat Key, Florida | 34228 LOT 19 | TOWN OF LONGBOAT KEY | MANARIEC COUNTY

DRAWING TITLE

UPPER LEVEL FLOOR PLAN

SHEET NUMBER

A2.2

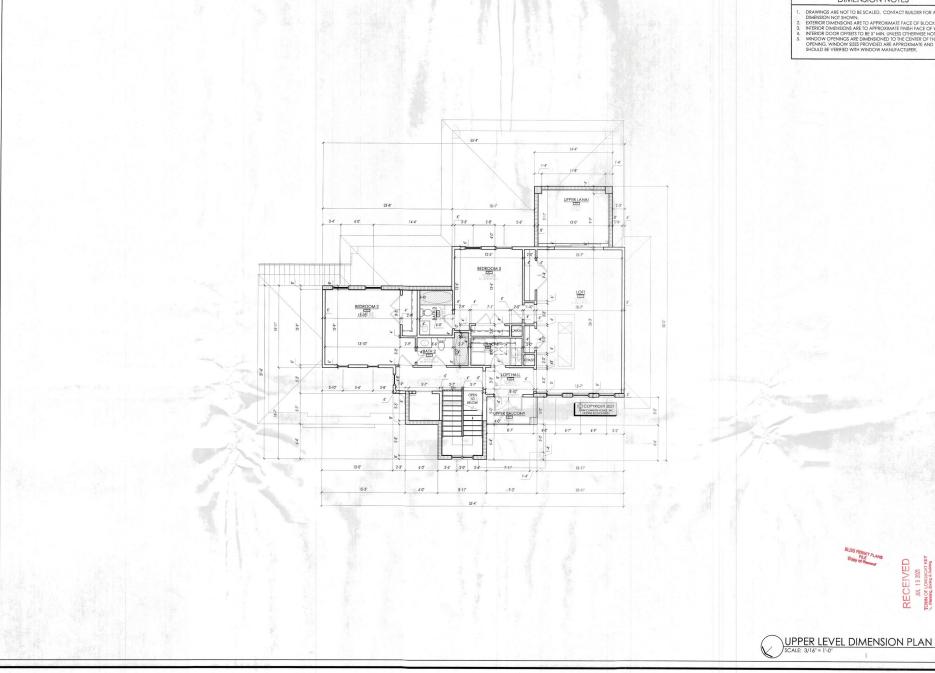

DIMENSION NOTES

DRAWINGS ARE NOTTO BE SCALED. CONTACT BUILDER FOR ANY DIMENSION NOT SHOWN.

DETRICOR DIMENSIONS ARE TO APPROXIMANTE FACE OF BLOCK. STRENGT DIMENSIONS ARE TO APPROXIMANTE FRIEND FACE OF WALL. INFERIOR DOOR OFFSETS TO BE 5° MIN. UNILESS OTHERWISE NOTICE. WINDOW OPENIORS ARE DIMENSIONED TO THE CORNER OF THE OPENIOR, WINDOW OPENIORS ARE DIMENSIONED TO THE CORNER OF THE OPENIOR, WINDOW SIZES PROVIDED ARE APPROXIMANTE AND SHOULD BE VERTICE WITH WINDOW ANALYSICATIONS.

ANEW CUSTON RESDENCE FOR ANTHONY & VICKI SKIDMORE 608 Boylew Drive Londboat Key, Florida 1 2 June LOT 191 TOWN OF LONDOOT Key, Florida 1 2 June 100 191 TOWN OF LONDOOT Key, Florida 1 2 June 100 191 TOWN OF LONDOOT FOR T




DRAWING TITLE

UPPER LEVEL DIMENSION PLAN SHEET NUMBER

RECEIVED
JUL 19 2021
TOWN OF LONGBOAT KEY
Flamming, Zoning & Building

A2.2d

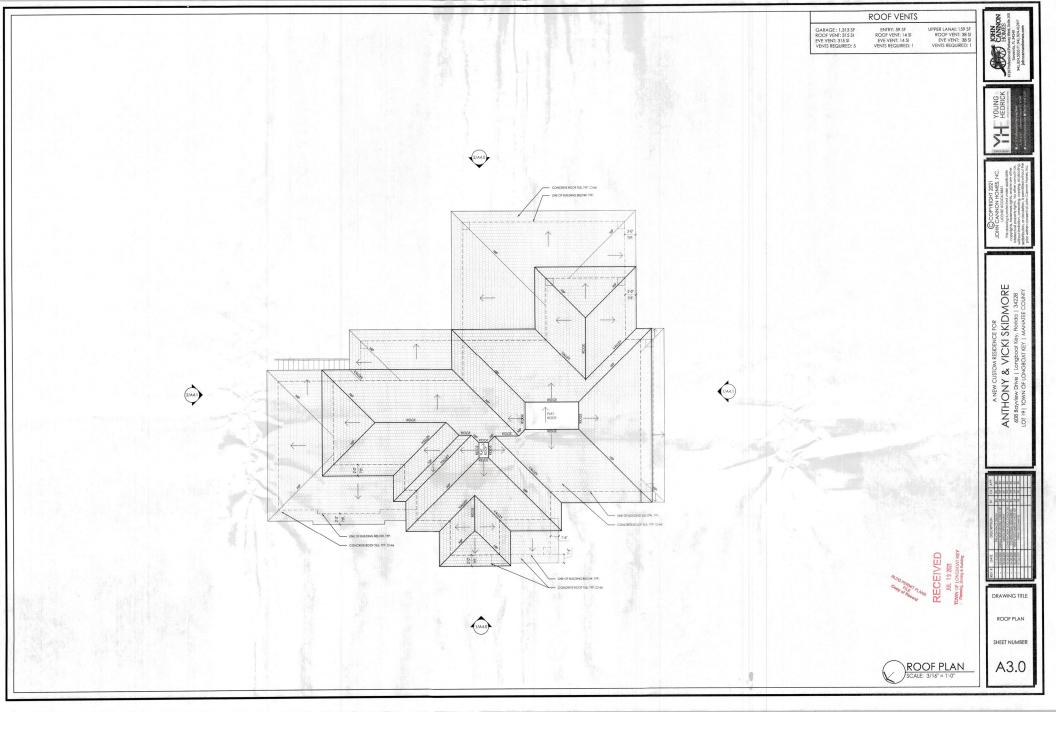



TYPICAL COMPOSITE BRACKET DETAILS 271 F 4 COMPOSITE RAFTER TAIL COMPOSITE LARGE BRACKET

JOHN CANNON HOMES

B

YOUNG

天

ELEVATION NOTES

- 5/8" SAND FRISH CEMENTITIOUS PARGE COAT OVER CONCRETE MASOARY UNITS OR 7/8" SAND FRISH CEMENTITIOUS PARGE COAT OVER PAPERSACK WIRE LAHTH OVER TIOUSE WRAP AND 1/2" SHEATING, U.N.O. PARGE COAT TO FINISH 4" BELOW FRISH GRADE WINTY CERUNGS TO BE PARGE COAT OVER EXPANDED RIS METAL.

FRONT (NORTH) ELEVATION



STOM RESIDENCE FOR & VICKI SKIDMORE I Longboat Key, Ronda | 34228 NGBOAT KEY | MANATEE COUNTY

ANTHONY & V
608 Bayview Drive | Long
LOT 19 | TOWN OF LONGBG

DRAWING TITLE EXTERIOR **ELEVATIONS**


RECEIVED

Auto 16 2021


TOWN OF LONGBOATHEY
Planning, Zoning 8 Building


SHEET NUMBER


A4.0

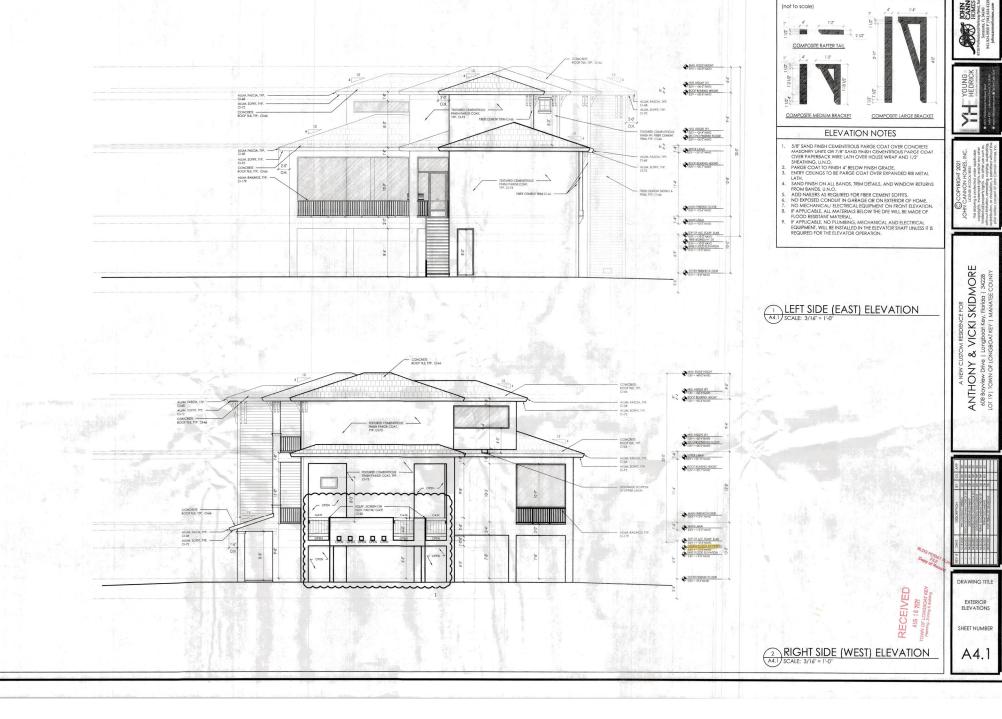

TYPICAL COMPOSITE BRACKET DETAILS

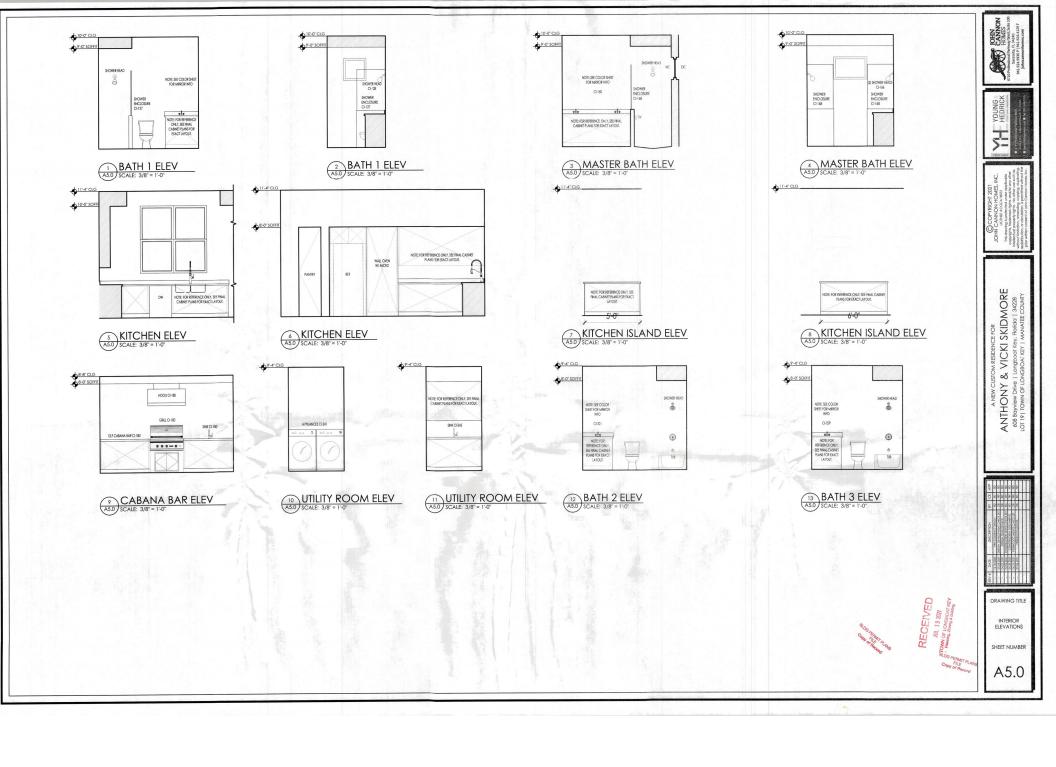

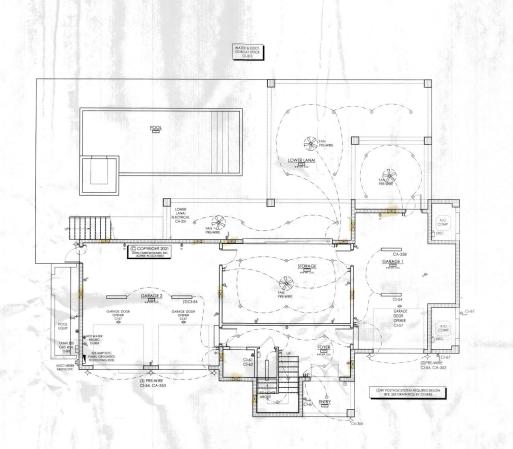

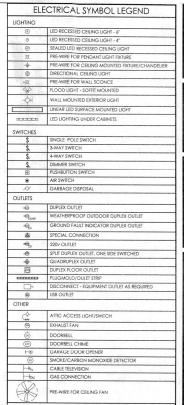

ELECTRICAL NOTES

STRUCTURED WIRING SYSTEM: (6) ACTIVE DUAL PORT JACKS (6 TV/6 DATA) WITH STRUCTURED WIRE ENCLOSURE AND 110 OUTLET, ONE MINI HOUSE CONTROLLER.

DATA) WITH STRUCTURED WIRE ENCLOSURE AND 110 OUTLET, ONE MIN HOUSE CONTROLLER.

2. ALL ELECTRICAL TO BE INSTALLED ABOVE BPE. UNLESS OTHERWISE INDICATED.

3. DATE OF THE STATE OF THE STATE







YOUNG


VICKI SKIDMORE ANTHONY & 608 F



DRAWING TITLE GROUND LEVEL ELECTRICAL PLAN

SHEET NUMBER

A6.0

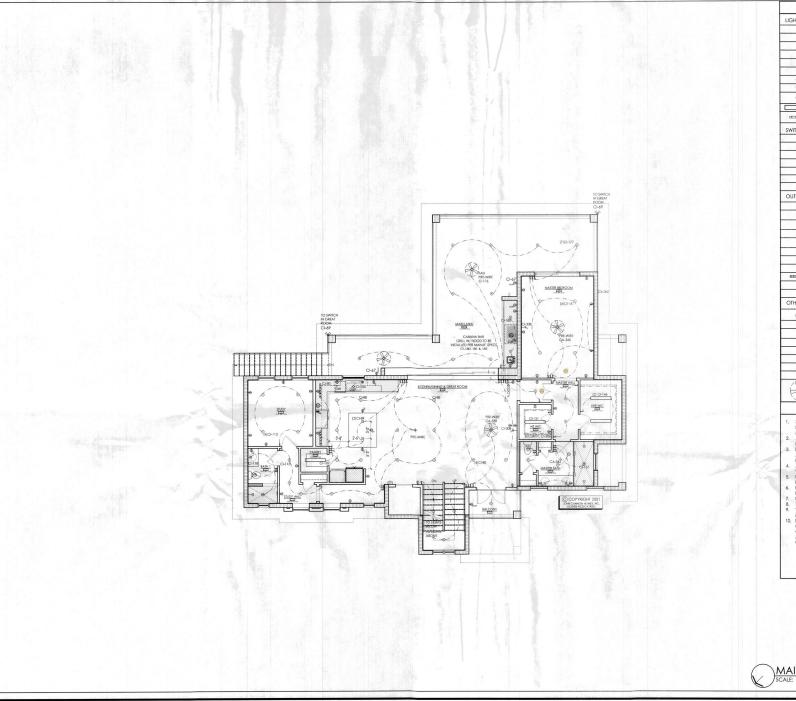



ELECTRICAL NOTES





RECEIVED
JUL 13 2021
TOWN OF LONGSOAT KEY



CANING



VICKI SKIDMORE ANTHONY & V
608 Bayview Drive | 1077




DRAWING TITLE

MAIN LEVEL ELECTRICAL PLAN

SHEET NUMBER

A6.1

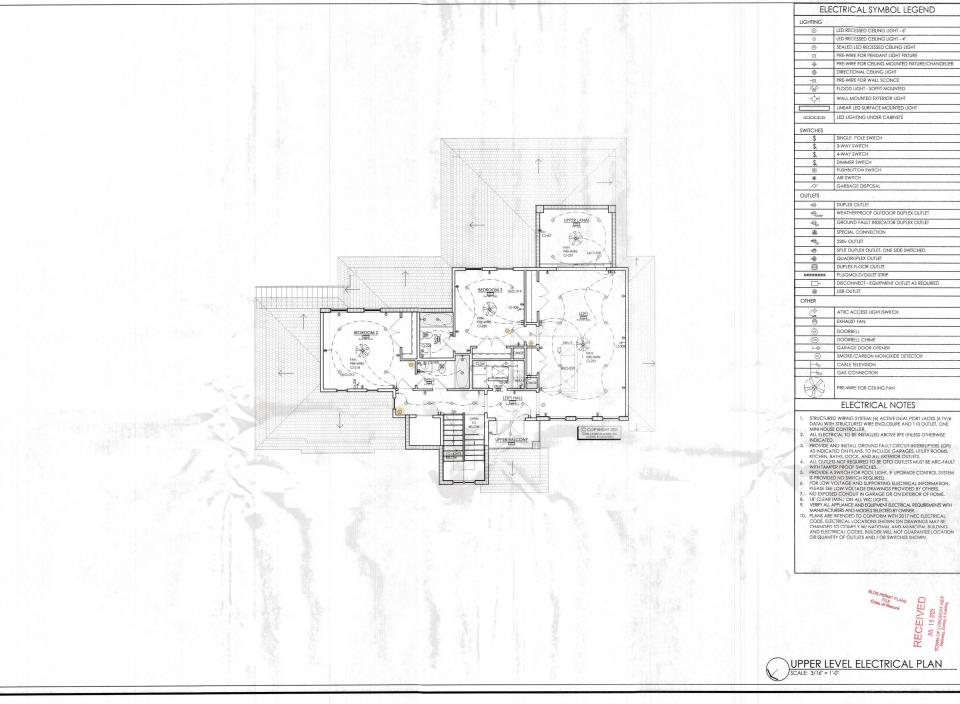



ELECTRICAL NOTES

- STRUCTURED WIRING SYSTEM: (6) ACTIVE DUAL PORT JACKS (6 TV/6 DATA) WITH STRUCTURED WIRE ENCLOSURE AND 110 OUTLET, ONE MINI HOUSE CONTROLLER.










VICKI SKIDMORE ∞ŏ ANTHONY 608 Bayviev LOT 19 | TOW

DRAWING TITLE

UPPER LEVEL ELECTRICAL PLAN

SHEET NUMBER

A6.2

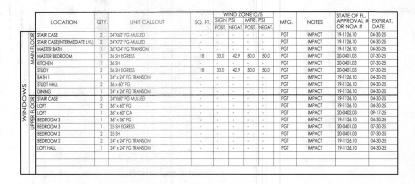

			7	WIND ZONE C/5		1 1 12	700	STATE OF FL.					
	LOCATION		QTY.	UNIT CALLOUT	SQ. FT.	SIGN PSI		MFR. PSI		MFG.	NOTES	APPROVAL #	EXPIRAT.
	1					POSIT.	NEGAT.	POSIT.	NEGAT.	1		OR NOA #	DATE
	FOYER	SECTION OF	1	(2)3'-0" x 8'-0" O/S IMPACT GLAZED				-		THERMATRU	IMPACT	FL-21142.10	12.31.21
	GARAGE	1	1	9070 OVERHEAD GARAGE DOOR		-	-	- 1	-19	CLOPLAY	IMPACT	17-0206.11	03.30.22
	GARAGE	1	11	2880 OS - Solid Core/1Hr Rated				- 1		THERMATRU	IMPACT	FL-21142.4	12.31.21
	STORAGE		1	T6080 2GD			-	-	-	PGT	IMPACT	19-1126.04	03-24-25
- 1	GARAGE	2	1 (2880 OS - Solid Core/1Hr Rated	-	-	-	-	-	THERMATRU	IMPACT	FL-21142.4	12.31.21
SS	GARAGE	2	2	9070 OVERHEAD GARAGE DOOR	13.62	-	-	-	-	CLOPLAY	IMPACT	17-0206.11	03.30.22
6	BALCONY	1	1	(2)3'-0" x 8'-0" O/S IMPACT GLAZED			-	-	-	THERMATRU	IMPACT	FL-21142.10	12.31.21
Χľ	MASTER B	EDROOM	1	8080 SGD EGRESS	1 1		-	-	- 1	PGT	IMPACT	19-1126.04	03-24-25
	GREAT RO	MOC	1	160100 PKT SGD	-	-	-	-	-	PGT	IMPACT	19-1126.04	03-24-25
	Z Z	- 3			-							10000	-
8	ž										akisa L		
1	UPPER BA	LCONY	_1	(2)3'-0" x 8'-0" O/S IMPACT GLAZED			200		-	THERMATRU	IMPACT	FL-21142.10	12.31.21
- 1	LOFT	H. 689.8	1	9080 PKT SGD			- "	-		PGT	IMPACT	19-1126.04	03-24-25
- 1	-	100	21 30 8	SC TOTAL PORT OF THE PARTY OF T		1	14	- 37	113		2530	1000	3
	The same of the sa	Lacar William	916			185					Carlotte Co	1.1	
	S C C C C C C C C C C C C C C C C C C C				20.50	3			1-1		1000		
1	163545	- S. J. July	Z-1-1		No.				1000		12-97		100

CATEGORY	SUB CATEGORY	PRODUCT DESCRIPTION	MANUFACTURER	STATE OF FL. APPROVAL # OR NOA #	EXPIRAT. DATE
WINDOWS					
Philippe States	FIXED	SERIES PW-5520 VINYL FIXED WINDOWS	PGT	19-1126.10	04-30-25
100	CASEMENT	SERIES CA-5540 VINYL CASEMENT WINDOW	PGT	20-0402.03	09-17-25
Tel massa	SINGLE HUNG	SERIES SH-5500 VINYL SINGLE HUNG WINDOW	PGI	20-0401.03	07-30-25
EXT. DOORS					
31. 35	SERVICE	THERMATRU I/S O/S IMPACT SINGLE SERVICE DOOR	THERMATRU	FL-21142.4	12-31-21
	SINGLE	THERMATRU I/S O/S IMPACT SINGLE GLAZED	THERMATRU	FL-21142.10	12-31-21
	DOUBLE	THERMATRU I/S O/S IMPACT DOUBLE GLAZED	THERMATRU	FL-20470.12	12-31-21
D	SGD	SERIES 770HP ALUMINIUM SLIDING GLASS DOORS	PGT	19-1126.04	03-24-25
16.	GARAGE OHD	W6 DP38T STEEL SECTIONAL GARAGE DOOR UP TO 18'	CLOPAY	17-0206.11	03-30-22
MISC.	-		The same	1000	44.55
1000	ROOFING TILE	CONCRETE ROOF TILE	EAGLE ROOFING	21-0315.03	10-05-26
	UNDERLAYMENT	BORAL TILESEAL	BORAL	18-0502.03	08-02-23
	ROOF VENTS	O'HAGINS CLOAKED VENT TILE	O'HAGINS	19-0109.02	04-04-24
to a	SIDING/SOFFIT	FIBER CEMENT SIDING/SOFFIT	JAMIES HARDIE	17-0406.06	05-01-22



YOUNG HEDRICK

JOHN CANNON HOMES, INC.

104N CANNON HOMES, INC.

11st glowing a protection under copy when the protection of the protec

A NEW CUSTOM RESIDENCE FOR
ANTHONY & VICKI SKIDMORE
608 Baywiew Drive | Longboat Key, Florida | 34228
LOT 191 TOWN OF LONGBOAT KEY | MANATEE COUNTY

| NATE | DECEMBER | 31 | CA | APP | CA | APP


DRAWING TITLE


SCHEDULES AND NOTES

RECEIVED
ANG 16 2021
TOWN OF LONGBOAT KEY
PHENTING, ZOND & BUSING

SHEET NUMBER

A7.0

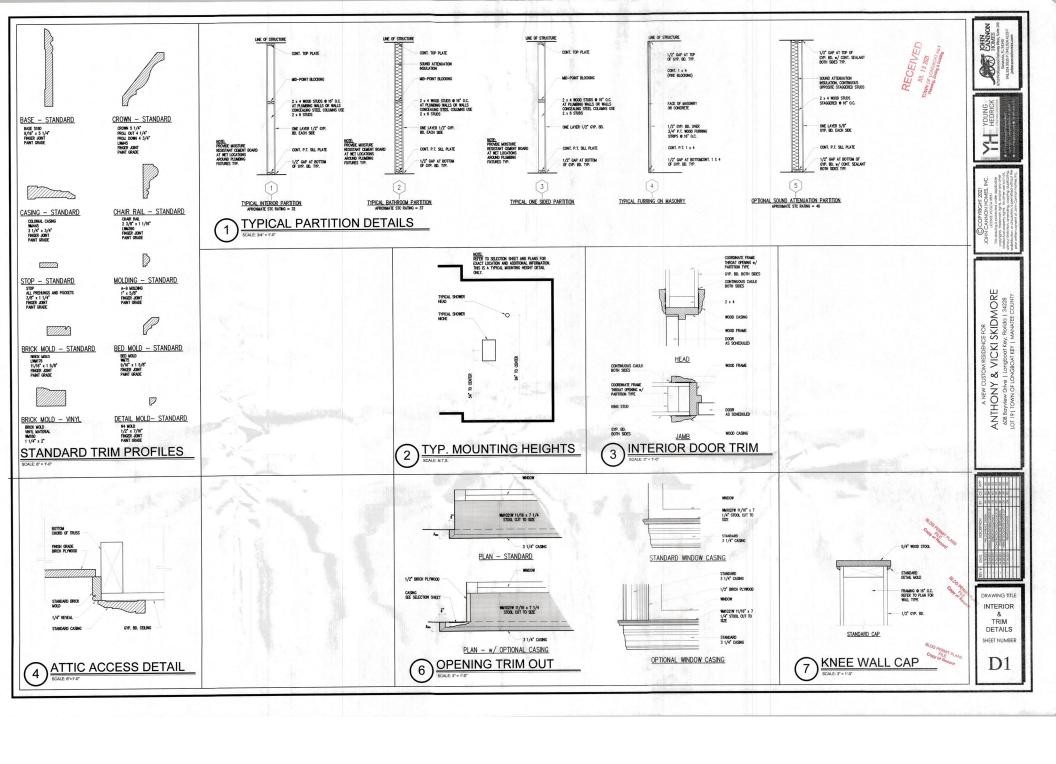

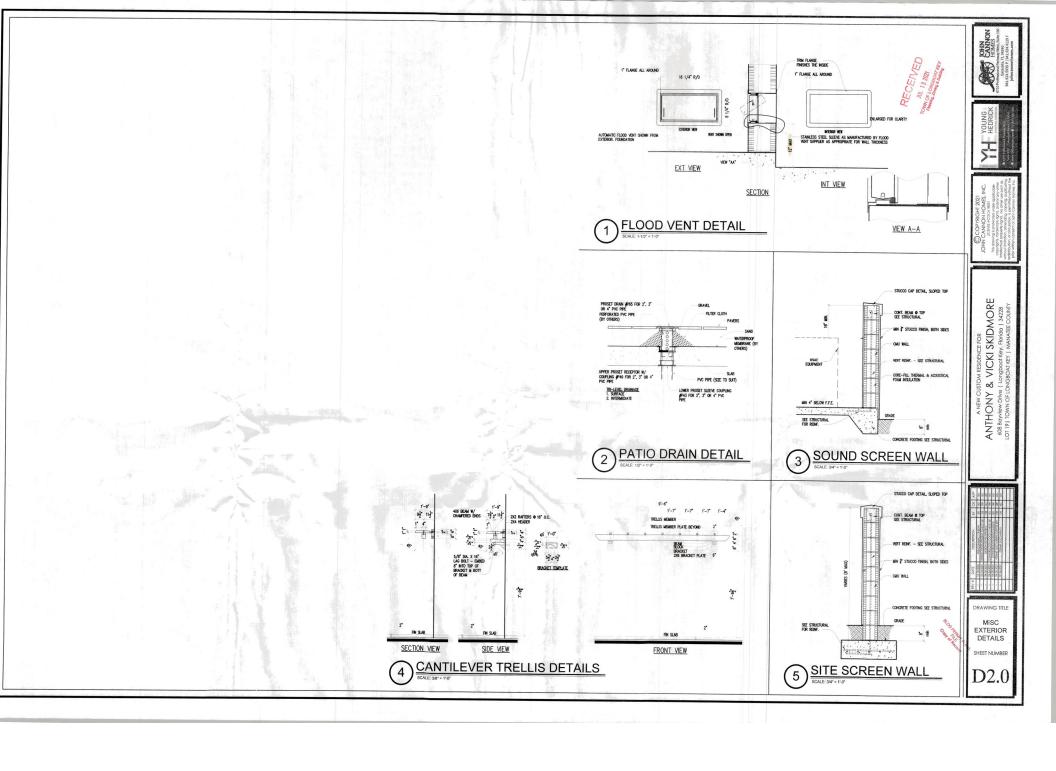




A Custom Home for:
ANTHONY & VICK! SKIDMORE
608 BAYVIEW DRIVE, LONGBOAT KEY, FL 34228

FOUNDATION PLAN

REVISIONS 06.09.2021

S1



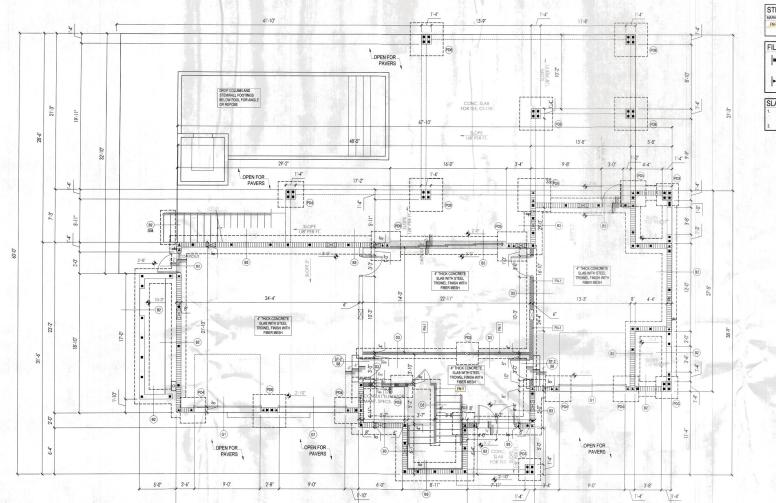

OPEN FOR PAVERS

67'-10"

18'-8"

25'-0"

FOUNDATION GENERAL NOTES

CUONDATION GENERAL NOTES

OONIGERING ADDION 10 COURSETE ALS

DONG SOLE FOOTING SEE FROMFAN - SEE

OONIG SOLE FOOTING SEE FROMFAN - SEE

OONIG SOLE FOOTING SEE FROMFAN - SEE

OONIG SOLE FOOTING SEE AND SEEL FOOTING SOLE FOOTING SOLE FOOTING SOLE FOOTING SEEL FOOTING SE

STRUCTURAL SCHEDULE MARK DESCRIPTION

FINE

LOAD BEARING WALL ANCHORAGE - ATTACH PT BOTTOM PLATE
TO FOOTING WITH * XP TITIEN HOS AT 16" O.C.


FILLED CELLS

INDICATES FILLED CELL W/ 1-NO.5 REBAR CONTINUOUS FROM TIE-BEAM (OR FOOTING) AT LEVEL BELOW TO TIE-BEAM ABOVE, PROVIDE 8" HOOKS

INDICATES FILLED CELL W/ 2-NO.5 REBAR CONTINUOUS FROM TIE-BEAM (OR FOOTING) AT LEVEL BELOW TO TIE-BEAM ABOVE PROVIDE 8" HOOKE


SLAB GENERAL NOTES

4" THICK 3000 PSI CONORETE SLAB WITH STEEL TROWEL FINISH WITH FIBER ADDITIEVE ON 6 MIL PLASTIC VAPOR BARRIER LAPPED 6" AND TAPED ON CLEAN COMPACTED FILL SEE SHEET 54 "GENERAL NOTES" FOR COMPACTION REQ'S.

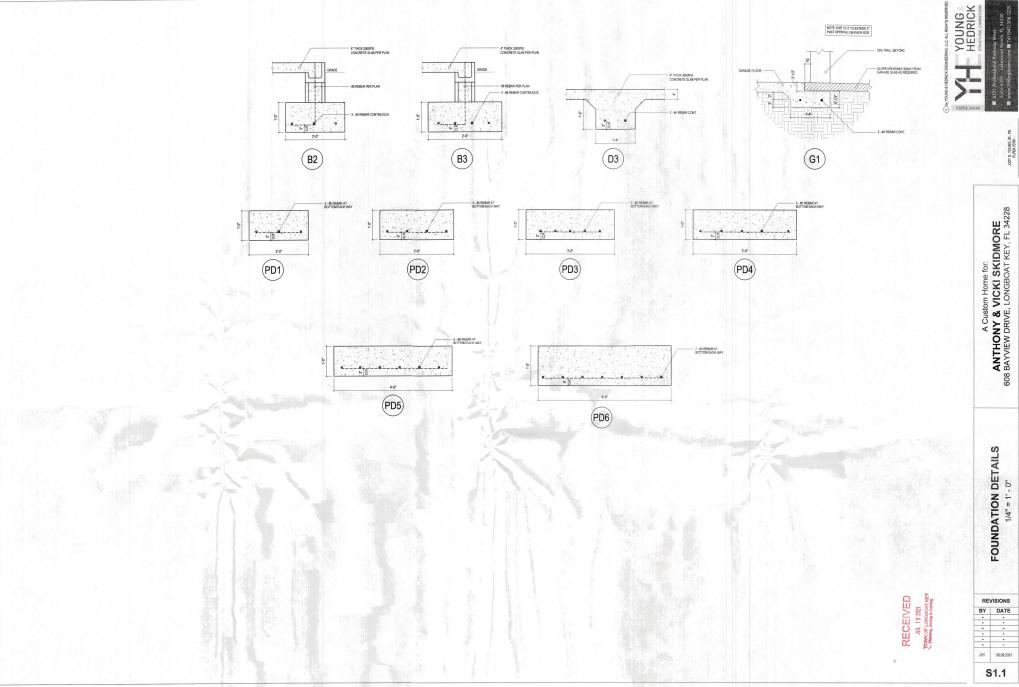

FOUNDATION DETAILS
1/4" = 1' - 0"

REVISIONS

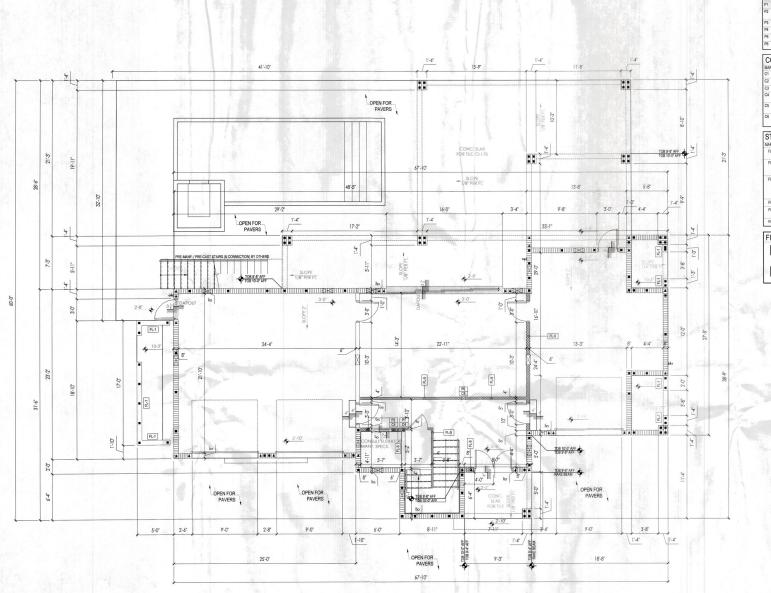

YOUNG & HEDRICK POST SCHEDULE DESCRIPTION 2-2X SPF NO. 2 MATCH WALL THICKNESS 2-2X SPF NO. 2 PATCH WALL THICKNESS
2-2X SPF NO. 2 POOT WITH ADDITIONAL JACK STUDS (AT HEADER)
MATCH WALL THICKNESS
3) "X 3" VERSALAM 18 2759 COLUMN
3) "X 5" VERSALAM 18 2759 COLUMN
3) "X 7" VERSALAM 18 2750 COLUMN 5(* X 5(* VERSALAM 1.8 2750 COLUMN

CONNECTOR SCHEDULE

MARK DESCRIPTION
C1 1-SIMPSON CS16 TO BEAMWALL BELOW
C2 2-SIMPSON CS16 TO BEAMWALL BELOW

3-SIMPSON CS16 TO BEAMWALL BELOW

SOMEON AST 119 WE FOR ALL THE WE FOR THE ADDRESS OF THE AST 119 WE FOR ALL THE ADDRESS OF THE AST 119 WE FOR ALL THE ADDRESS OF THE AST 119 WE FOR ALL THE ADDRESS OF THE AST 119 WE FOR ALL THE AST 119 WE FOR 119 WE FOR AST 119 WE FOR 119 WE FOR AST 119 WE FOR 119 WE

STRUCTURAL SCHEDULE

MARK DESCRIPTION
FL-1
CON LOW WALL - 1-NO.5 REBAR CONT. IN FILLED COURSE AT TOP OF WALL NICHE PER ARCHITECTURAL FRONT ELEVATION -USE 4" MASONRY FOR WALLS WITH FILLED CELLS & REBAR PER PLAN

FL-3
2-2X8 PT NAILED TOGETHER WITH 12d NAILS 6" O.C. STAGGERED ATTACH TO CMU WALL WITH SIMPSON HGAM10KT AT 24" O.C. VERTICALLY, & PLYWOOD ON EXTERIOR WITH 8d NAILS 4" O.C. EDGE/8" O.C. FIELD

FRAME-OUT INTERIOR CORNER OF COLUMN (NON-STRUCTURAL)

FL-5 LOAD BEARING WALL - 2X SPF STUDS 16" O.C. TOP AT 8"-8" AFF (LOWER AT STAIRS)

FL-6 FILL ALL CELLS

FILLED CELLS

■ INDICATES FILLED CELL WI 1-N-0.5 REBAR CONTINUOUS FROM TIE-BEAM (OR FOOTING) AT LEVEL BELOW TO TIE-BEAM ABOVE, PROVIDE 8" HOOKS

INDICATES FILLED CELL W/2-NO.5 REBAR CONTINUOUS FROM TIE-BEAM (OR FOOTING) AT LEVEL BELOW TO TIE-BEAM ABOVE, PROVIDE 8" HOOKS

RECEIVED
JUL 19 2021
TOWN OF LONGBOAT NEY
TOWN OF LONGBOAT NEY

STRUCTURAL FLOOR PLAN 1/4" = 1' - 0"

REVISIONS BY DATE JDY 06.09.2021

A Custom Home for:
ANTHONY & VICKI SKIDMORE
608 BAYVIEW DRIVE, LONGBOAT KEY, FL 34228


S2

10





S2.1

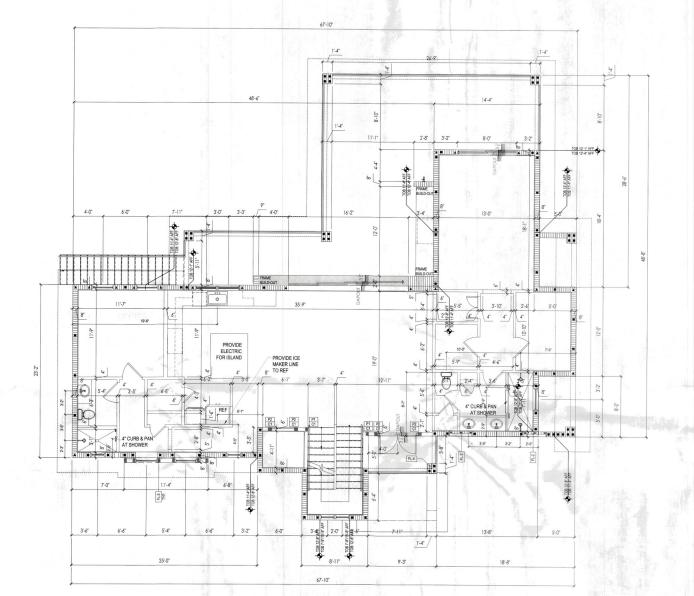

P05	ST SCHEDULE	P
MARK	DESCRIPTION	
P1	2-2X SPF NO. 2 MATCH WALL THICKNESS	
P2	2-2X SPF NO. 2 POST WITH ADDITIONAL JACK STUD MATCH WALL THICKNESS	IS (AT HEADER
P3	3] " X 3]" VERSALAM 1.8 2750 COLUMN	
P4	3½ " X 5½" VERSALAM 1.8 2750 COLUMN	
P5	35 ° X 7" VERSALAM 1.8 2750 COLUMN	
P6	5]* X 5]* VERSALAM 1.8 2750 COLUMN	

	NECTOR SCHEDULE
MARK	DESCRIPTION
C1	1-SIMPSON CS16 TO BEAMWALL BELOW
C2	2-SIMPSON CS16 TO BEAMWALL BELOW
C3	3-SIMPSON CS16 TO BEAMWALL BELOW
C4	1-SIMPSON LTT19 W/ §* DIA. ALL-THREAD DRILLED & EPOXIED 4* INTO FOOTING WITH SIMPSON SET EPOXY (T=1310#)
C5	1-SIMPSON HTT4 W/§* DIA, ALL-THREAD DRILLED & EPOXIED 4* INTO FOOTING WITH SIMPSON SET EPOXY (T=3810#)
C6	1-SIMPSON HTTSKT W/ (*) DIA. ALL-THREAD DRILLED & EPOXIED 5' INTO FOOTING WITH SIMPSON SET EPOXY (T=5445#)

MARK	DESCRIPTION
FL-1	CMU LOW WALL - 1-NO.5 REBAR CONT. IN FILLED COURSE AT TOP OF WALL
FL-2	NICHE PER ARCHITECTURAL FRONT ELEVATION - USE 4" MASONRY FOR WALLS WITH FILLED CELLS & REBAR PER PLAN
FL-3	2-2X8 PT NAILED TOGETHER WITH 12d NAILS 6" O.C. STAGGERED ATTACH TO CMU WALL WITH SIMPSON HOAM10KT AT 24" O.C. VERTICALLY, §" PLYWOOD ON EXTERIOR WITH 8d NAILS 4" O.C. EDGER" O.C. FIELD
FL-4	FRAME-OUT INTERIOR CORNER OF COLUMN (NON-STRUCTURAL)
FL-5	LOAD BEARING WALL - 2X SPF STUDS 16" O.C. TOP AT 8'-8" AFF (LOWER AT STAIRS)
FL-6	FILL ALL CELLS

FILLED CELLS

INDICATES FILLED CELL W/ 1-NO.5 REBAR CONTINUOUS FROM TIE-BEAM (OR FOOTING) AT LEVEL BELOW TO TIE-BEAM ABOVE, PROVIDE 8" HOOKS


INDICATES FILLED CELL W 2-NO.5 REBAR CONTINUOUS FROM TIE-BEAM (OR FOOTING) AT LEVEL BELOW TO TIE-BEAM ABOVE, PROVIDE 8" HOOKS

RECEIVED
JUL 19 2021
TOWN OF LONGSOAT KEY

P





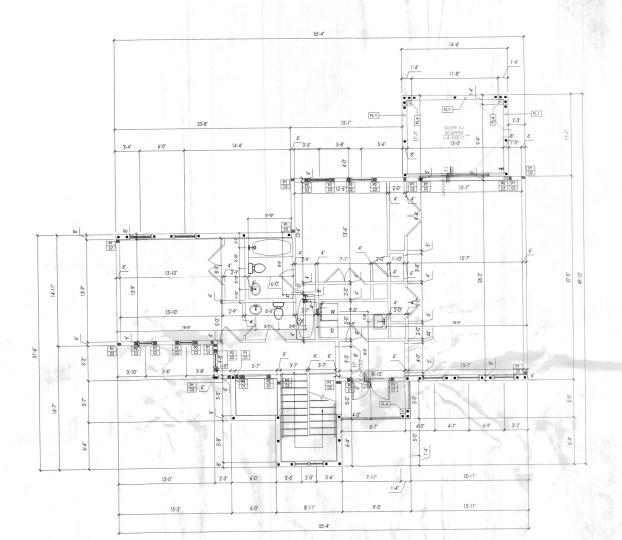

POST SCHEDULE DESCRIPTION
2-2X SPF NO. 2 MATCH WALL THICKNESS
2-2X SPF NO. 2 POST WITH ADDITIONAL JACK STUDS (AT HEADER)
MATCH WALL THICKNESS 33 * X 33 * VERSALAM 1.8 2750 COLUMN 33 * X 53 * VERSALAM 1.8 2750 COLUMN 34 * X 7 * VERSALAM 1.8 2750 COLUMN 5% X 5% VERSALAM 1.8 2750 COLUMN


CON	NECTOR SCHEDULE
MARK	DESCRIPTION
C1	1 SIMPSON CS16 TO BEAMWALL BELOW
C2	2-SIMPSON CS16 TO BEAMWALL BELOW
C3	3-SIMPSON CS16 TO BEAMWALL BELOW
C4	1-SIMPSON LTT19 W/ § DIA, ALL-THREAD DRILLED & EPOXIED 4" INTO FOOTING WITH SIMPSON SET EPOXY (T=1310#)
C5	1-SIMPSON HTT4 W/ \$" DIA. ALL-THREAD DRILLED & EPOXIED 4" INTO FOOTING WITH SIMPSON SET EPOXY (T=3610#)
C6	1-SIMPSON HTTSKT WI TO DIA, ALL-THREAD DRILLED & EPOXIED 5 INTO FOOTING WITH SIMPSON SET EPOXY (T=5445#)

	UCTURAL SCHEDULE FL1
MARK	DESCRIPTION
FL-1	CMU LOW WALL - 1-NO.5 REBAR CONT, IN FILLED COURSE AT TOP OF WALL
FL-2	NICHE PER ARCHITECTURAL FRONT ELEVATION - USE 4" MASONRY FOR WALLS WITH FILLED CELLS & REBAR PER PLAN
FL-3	2-2x8 PT NAILED TOGETHER WITH 12d NAILS 6" O.C. STAGGERED ATTACH TO CAIU WALL WITH SIMPSON HGAM10KT AT 24" O.C. VERTICALLY, ¹⁵ PLYWOOD ON EXTERIOR WITH 8d NAILS 4" O.C. EDGER® O.C. FIELD
FL-4	FRAME-OUT INTERIOR CORNER OF COLUMN (NON-STRUCTURAL)
FL-5	LOAD BEARING WALL - 2X SPF STUDS 16" O.C. TOP AT 8'-8" AFF (LOWER AT STAIRS)
FL-6	FILL ALL CELLS

FILLED CELLS

INDICATES FILLED CELL WILLIAMS REBAR CONTINUOUS FROM TIE-BEAM (OR FOOTING) AT LEVEL BELOW TO TIE-BEAM ABOVE, PROVIDE 8" HOOKS

INDICATES FILLED CELL W/ 2-NO.5 REBAR CONTINUOUS FROM TIE-BEAM (OR FOOTING) AT LEVEL BELOW TO TIE-BEAM ABOVE PROVIDE 8' HOOKS

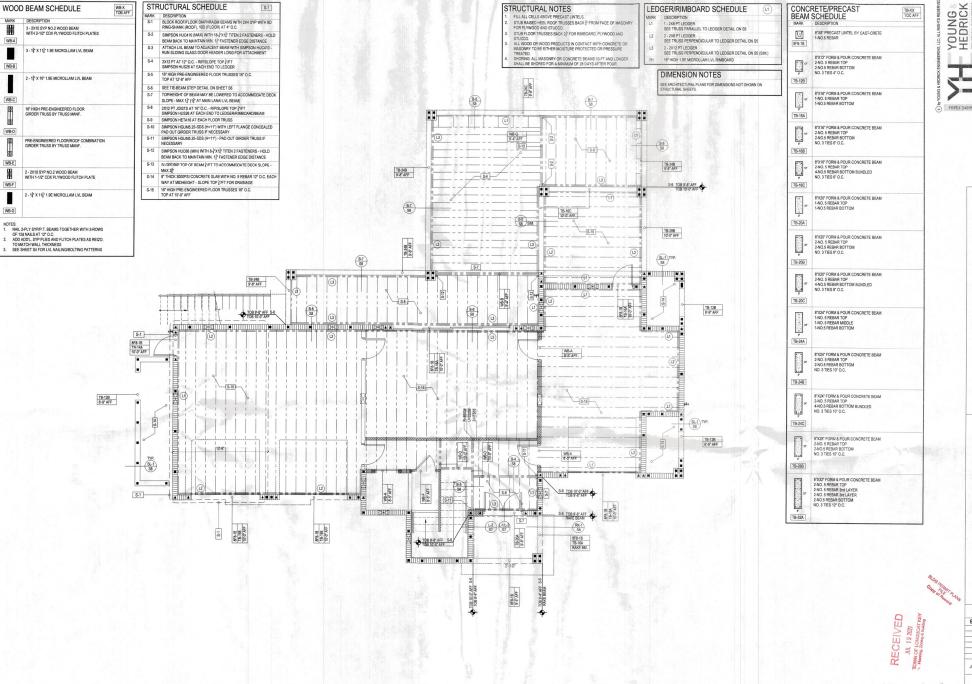

FBPF# 3489


A Custom Home for:
ANTHONY & VICKI SKIDMORE
608 BAYVIEW DRIVE, LONGBOAT KEY, FL 34228

MAIN LEVEL FRAMING PLAN 1/4" = 1' - 0"

REVISIONS BY DATE -JDY

06.09.2021

S3

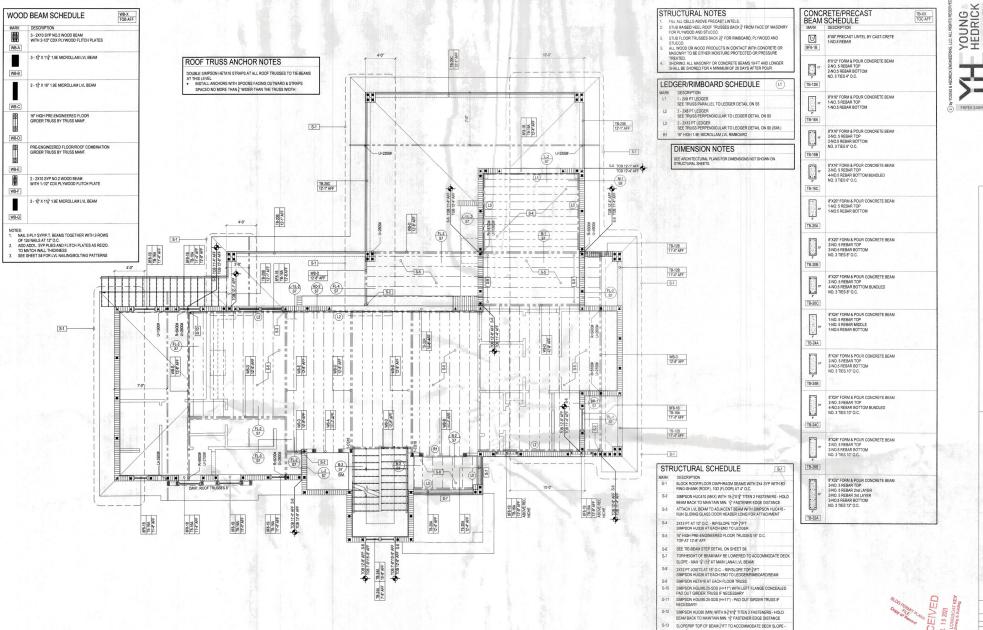




S-14 8" THICK 3000PSI CONCRETE SLAB WITH NO. 5 REBAR 12" O.C. EACH WAY AT MIDHEIGHT - SLOPE TOP LIFT FOR DRAINAGE
S-15 16" HIGH PRE-ENGINEERED FLOOR TRUSSES 16" O.C.
TOP AT 10"-0" AFF


UPPER REVISIONS BY DATE JDY 06.09.2021

A Custom Home for:
ANTHONY & VICKI SKIDMORE
608 BAYVIEW DRIVE, LONGBOAT KEY, FL 34228

LEVEL FRAMING PLAN

S3.1

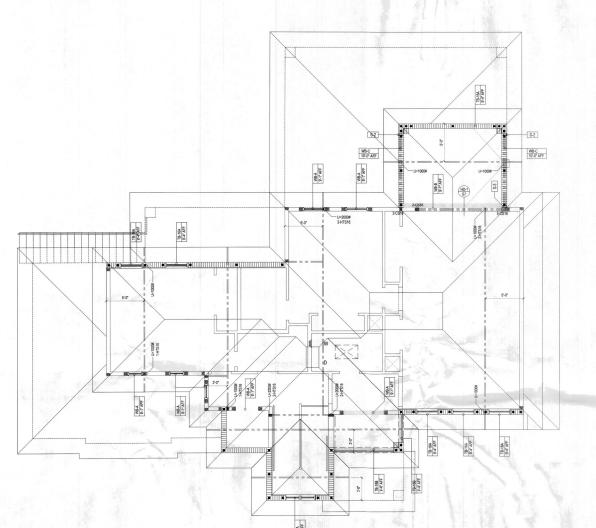

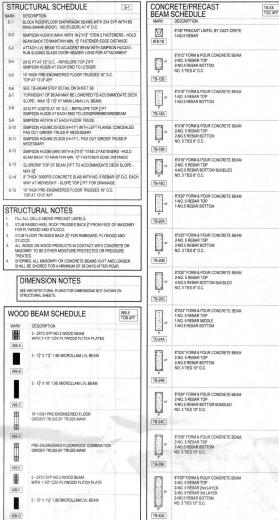

NOTES.

1. NAIL 2-PLY SYPIP.T. BEAMS TOGETHER WITH 2-ROWS OF 12d NAILS AT 12° O.C.

2. ADD ADDL. SYP PLIES AND FLITCH PLATES AS REQ'D. TO MATCH WALL THICKNESS SEE SHEET S4 FOR LVL NAILING/BOLTING PATTERNS



RECEIVED
JUL 19 2021
TOWN OF LONGEDAT KEY
SMAN OF LONGEDAT KEY

REVISIONS BY DATE JDY 06.09.2021

S3.2

YOUNG RHEDRICK

A Custom Home for:
ANTHONY & VICKI SKIDMORE
608 BAYVIEW DRIVE, LONGBOAT KEY, FL 34228

ROOF FRAMING PLAN 1/4" = 1' - 0"

1. GENERAL NOTES

- FIG. BETTERS TO DOOR FLOWER SILLING LOCKE, THE ESTITUM.
 COMMUTE SHOW ALL MADE OF THE COMMUNE RESERVOIRS.
 COMMUTE SHOW ALL MADE OF THE SHOW ALL MADE OF THE SHOW AND AREA PLUS A
 MANISOR OF SHE FOR THOSE FREMENTES IN SHESS SHEET TO A MANISOR THE SHESS SHEET TO A MANISOR THE SHESS SHEET TO A MADE OF THE SHESS SHEET TO A MADE OF THE SHESS SHEET TO A MADE OF THE SHESS SHEET THE SHESS SHEET SHESS SHEET THE SHEET SHEET

- FOUNDATIONS HAVE BEEN DESIGNED FOR AN ALLOWABLE BEARING CAPACITY
- OF 2001 PS.
 CONTRACTOR TO VERIETY MANUFACTURED TRUSS PLAN PRIOR TO PLACEMENT OF STEWARL OR MONOLTHIC FOOTING.
 PUBBER ST ON PISCAN SUPERITY MONEY OF YEAR SHOWN WHICH UTILIZES A MASONEY WHAL TO RESOLVE ANY POSSIBLE STRUCTURAL INTEGRITY SOLES. 18

2. CONCRETE/MASONRY NOTES

- ALL CONCRETE SHALL BE Fo=3000PSI.
 MASONRY SHALL USE TYPE S MORTAR. Pm=1900PSI.
 REINFORCING STEEL SHALL SATISFY ASTM A615, GD 90. FOOTING MAY USE
- REINFORCING STEEL SHALL SATIEFY ASTIM AHS, GO DE FOOTING MAY USE 00 45 TEEL.
 WHERE RIDICATED ON FLOOR PLANS, PROVIDE CONCRETE FLLED CHI-WHER RIDICATED ON FLOOR PLANS, PROVIDE CONCRETE FLLED CHI-BEFORE INSPECTION. IF GROUT LIFT EXCEDS 4-19, AN INSPECTION HOLE TO VERBY GROUTING SHALL BE PROVIDED AT THE BOTTOM LEP PROVIDE (1) IS VERTICAL REINFORCING STEEL ELECTRICAL, GROUND TO FOUNDATION STEEL.
- FOUNDATION STEEL
 FOUNDATION DOWELS AND VERTICAL REINFORCING SPACES AS SHOWN ON FLOOR PLANS. IN THE EVENT OF CONFLICTS, THE FLOOR PLANS SHALL TAKE PRECEDENCE OVER THE FOUNDATION PLAN.
- LL FOOTINGS TO BE SMOOTH AND LEVEL. EINFORCING STEEL LAP LENGTH IN CONCRETE AND/OR MASONRY SHALL
 - #5 REBAR -30" #6 REBAR -36"
- IN NEEDER 4-06

 #F REBER 45

 AP ERSOTH OF INDIVIDUAL BARS WITHIN A BUNDLE SHALL BE THAT FOR
 THE INDIVIDUAL BAR, INCREASED 20% FOR THREE-BAR BUNDLE, AND 33%,
 FOR FOUR BAR BUNDLE.
 BONDIOUAL BARS WITHIN A BUNDLE TERMINATED WITHIN THE SPAN OF THE
 BEAM SHALL TERMINATE AT DIFFERENT FOINTS WITH AT LEAST 4006.
- BEAM OFFICE THE STAGGER
 FILLED CELL WITH (1) MS VERTICAL SHALL BE LOCATED AT GIRDER TRUSSES WITH UPLIFT EXCEEDING 2000LBS U.N.O.
- TRUSSES WITH URLIF EXCEEDING 2000.85 U.N.O.

 21 MINIMAM CONCRETE COVER O' CAST AGAMEST SOLU NO 1½ ELSE U.N.O.

 MAXIMAM CONCRETE COVER O' U.N.O.

 21 MEMEDIOE TRUSS ANCHORS SHILL BE INSTALLED IN ACCORDANCE WITH
 MANUFACTURER REQUIENEMIS.

 2.14 MEMEDIOE ANCHORSTREOWNS SHILL HAVE MIN 2' COVER.
- ASONRY WALLS SHALL BE BRACED IN ACCORDANCE WITH "STANDARD
- PRACTICE FOR BRACING MASONRY WALLS UNDER CONSTRUCTION*
 MASON CONTRACTORS ASSOCIATION OF AMERICA, JULY 2001.

 2.16 THE CONCRETE TIE BEAM AT TOP OF ALL WALLS SHALL BE AN 8"X16" WITH (1)
- 2.10 INC. CONSCRIED IN BEHAM AT 100°C MALT WALLS SMALL BEING A 10°C MIN.
 2.17 BEAM SIZES SHOWN ON DEAMINGS ARE MINIMAIN NOMINAL DIMENSIONS.
 BEAM SIZES SHOWN ON DEAMINGS ARE MINIMAIN NOMINAL DIMENSIONS.
 BEAM RECURREMENTS PROVIDED THAT THE DISTANCE BETWEEN TO READ
 BOTTOM REPROPERING STEEL REMAINS THE SAME ON IS INCREASED.

3. FRAMING NOTES

- 3.1 ALL DOOR HEADERS AT BEARING WALLS TO BE (2) 2X10 SYP OR BETTER, 3.2 EXTERIOR FRAME WALLS, BEARING OR NON BEARING, SHALL BE SHEATHED
- 12 ETTERIOR FAME WALLS EARNING FROM SHAULD SHAULD SHAULD WITH \$\frac{1}{2}\triangle \text{PMT-METAL PROVIDED ROW MAN WITH MAT OF C. \$120005. FOR C. FELD. \$120005. FOR C. FELD. \$120005. FOR C. FELD. \$120005. FOR C. FELD. \$120005. FOR C. FELD WALL SHAULD S

- 4. WOOD NOTES

- PSL: 1.8E PARALLEL STRAND LUMBER, Fb=2400psi
 LVL: 1.9E LAMINATED VENEER LUMBER, Fb=2600psi
 PT: PRESSURE TREATED SOUTHERN PINE #2 GRADE OR BETTER
- SPF: SPRUCE PINE FIR #2 GRADE OR BETTER

5. ROOF FRAMING NOTES

- THE DESIGN OF ROOF FRAMING SHALL BE BASED ON THE REQUIREMENTS
- OF THE FOCH.

 5.2 DESIGN WIND LOADS SHALL BE APPLIED IN ACCORDANCE WITH FBC SECTION
 1999. SEE WIND NOTES FOR WIND DESIGN REQUIREMENTS.

 5.3 ROOF TRUSS MANUFACTURES FAHLE SUBMIT AND PROVIDE COMPLETE
 LAYOUT AND FURNISH THE FOLLOWING INFORMATION. ROOF PROVI.
 LUMBER SULE, SPACING, SETIES AND GRANDING, LOCATION AND
- WAGNITUDE OF UPLIFT LOADS.
- PRE-ENGINEERED TRUSS DESIGN SHALL BE SIGNED AND SEALED BY A FLORIDA LICENSE PROFESSIONAL, HONGER, ROUGH, FROMER ROOF SHEATHING SHALL BE 1932' CO PLYMODO OR FOULL. FASTENED WITH AN BIRKL-SHAW MISS AT A" CO FLORED AND FOLD WITHIN 4"OF ROOES AND EDGES OF ROOF AND 2"C, WITHIN 4"OF CETEORR ROOF CORNING SHALL DEGES OF ROOF AND 2"C, WITHIN 4"OF CETEORR ROOF CORNING SO. CONTRACTORS SHALL VERBY WITH ROOF TRUSS PLAN PRIOR TO PLACEMENT OF FOOTHOIS.

6. DESIGN LOADS AND NOTES

ROOF TRUSSES - D+L OOF TRUSSES - D+L SSFSF WI 1.33 STRESS INCREASE FACTOR, OR 45PSF WI 1.25 STRESS INCREASE FACTOR, OR 41PSF WI 1.00 STRESS INCREASE FACTOR.

- FLOOR D+L 65PSF W/ 1.00 STRESS INCREASE FACTOR DL = 10PSF IN COMBINATION WITH WIND LOA
- DL * 10PS* IN COMBINATION WITH WIND LOADS.

 MEAN ROOF HEIGHT SHALL BE DETERMINED BY CONTRACTOR.

 LATERAL LOADS AT TOP OF EXTERIOR WALLS SHALL BE BASED ON 38.4 PSF
 ON WALL. LATERAL LOADS IN TRUSSES ARE RESISTED BY ROOF DIAPHRAGM AT POINT
- OF WIND LOAD INPUT U.N.O.
 TRUSS MANUFACTURERS TRUSS LAYOUT SHALL SHOW ALL CONNECTIONS
 BETWEEN TRUSSES AND OTHER TRUSSES AND BETWEEN TRUSSES AND
- WOOD BEAMS.

 ISSES MUST BE DESIGNED TO SUPPORT WALLS AGAINST OUT-OF-PLANE
 LOADS IN ACCORDANCE WITH ITEM 6.5. THIS APPLIES TO ALL TRUSSES
- LOADS IN ACCORDANCE WITH ITEMS. THIS APPLIES TO ALL TRISSES WITH A RASIC FLEE CONDITION THE TEST ON AN ECTERORY RALL. WITH A RESIDENCE OF THE PROPERTY OF TH

7. WIND NOTES

- 7.1 WIND LOADS ARE BASED ON A WIND VELOCITY OF 150 MPH APPLIED FOR A
- WIND LOUDS ARE BISED ON A WIND VELOCITY OF 150 MPH APPLIED TOWN THE PLULY PINCLOSES TRUCTURE.
 THIS BUILDING S DESIGNED AS A FILLY PINCLOSED BUILDING BASED ON ALL OPENINGS BEING PROTECTED OR HAWNO MISSILE IMPACT GLASS.
 WIND DESIGN LOADS WERE CETEMINED BASED ON THE FOLLOWING:
 BUILDING CATEGORY I, IMPORTANCE FACTOR = 1.0
 BUILDING CATEGORY I, IMPORTANCE FACTOR = 1.0
- WIND EXPOSURE = D, INTERNAL PRESSURE COEFFICIENT = 0.18. FULLY ENCLOSED BUILDING

	WIND PRESSURES PONENTS AND CL	
POSITIVE PRESSURES = INWA IEGATIVE PRESSURES = OUT ALL PRESSURE VALUES ARE I	WARD (SUCTION)	
COMPONENT AREA (SQ. FT.)	ZONE 4	ZONE 5
10	+46,4/-50.4	+46.4/-62.2
20	+44.5/-48.4	+44.5/-57.9
30	+43.3/-47.2	+43.3/-55.5
40	+42.1/-46.1	+42.1/-54.0
50	+41.7/-45.7	+41.7/-52.3
75	+40.6/-44.5	+40.6/-50.0
100	+39.4/-43.3	+39.4/-48.4
150	+38.2/-42.1	+38.2/45.7

8. PEST/DECAY PROTECTION NOTES

- AM HISTORY AND PROCESSORY SETS FOR AN A PERSON FOR A MANUFACTURE AND PROCESSORY AND A PERSON FOR A MANUFACTURE AND A PERSON FOR A

9. GARAGE NOTES

- ST OPENINGS FROM CHANGE INTO LIVING SPACE OF RESIDENCE SHALL MEET
 25 DUCTS IN THE CHANGE AND DUCTS PRESTRAINED THE MALLS OF CILILING
 SEPARATION FOR DEVILLAND FROM THE ANGENOUS SHALL MEET THE
 26 DUCKNESS OF THE SECTION NO.2.2.
 27 DUCKNESS OF THE SECTION NO.2.2.
 28 DUCKNESS OF THE SECTION NO.2.2.
 29 OF THE SECTION NO.2.
 20 OF THE SECTION NO.2

10. GENERAL CONNECTIONS NOTES

- 19.1 CONNECTIONS SHOWN AND RECOMMENDED, BUT OTHER COUNCETORS MAY AS SIGNETHUTED AS LOVA AS THEY WEST OR EXCELS IN FIFTH AND LAND AS THE WEST OR EXCELS IN FIFTH AND LAND AS THE PROPERTY OF THIS SIGNED AND LAND AS THE PROPERTY OF THIS SIGNED AND LAND AS THE PROPERTY OF THIS SIGNED AS THE PROPERTY OF THIS SIGNED AS THE PROPERTY OF THE

11. TRUSS TO FRAME CONNECTION NOTES

- 11.1 ROOF TRUSSES LIKE SAMPOON HIS OR HIS A TEACH TRUSS WHERE POSSIBLE PROVIDE ACTIONAL TECHNING FOR JUTY THE RODGES OF ORNA LICINAME MULES WHERE THE HIS CAMPOON THE GROUP (BUTY TO A CONTINUAL TECHNING AND A CONTINUAL TEC

12. EXTERIOR CEILING NOTES

12.1 ENTRYLAMAICABANA CELINGS (AREAS EXPOSED TO WIND): PROVIDE 2XA BLOCKING AT 45° OC AT THE BOTTOM CHORD OF ALL TRUSSES. PROVIDE "EXTERIOR GRADE DRYWALL OR "EXTERIOR GRADE PLYMCOD WITH 64 MAILS "O.O. FIELDH" OC. EDGES.

TRUSS UPLIFT ANCHORS - MASONRY/CONCRETE

TRUSS ANCHORS TO MASONRY OR CONCRETE SHALL BE AS FOLLOWS
(REFER TO SIMPSON 280 CATALOG 5L/2007)
OTHER BRANGS OF CONNECTORS MY ES BUSISTITUTED IF BOTH UPLIFT AND LATERAL LOAD CAPACITIES ARE EQUAL OR GREATER THAN CONNECTORS SPECIFED

TYPE MEMBER	NOMINAL UPLIFT CAPACITY	CONNECTOR TYPE	NAILS TO TRUSS FOR NOMINAL UPLIFT	NOTES AND COMMENTS
SINGLE PLY, CMU	5954	SIMPSON HM9KT	(4) SDS ['x1]" LONG TO TRUSS AND (5) ['x2]" SIMPSON TITEN SCREW TO CMU	POST-INSTALLED
SINGLE PLY, CONCRETE	595#	SIMPSON HM9KT	(4) SDS ['x1]" LONG TO TRUSS AND (5) ['x1]" SIMPSON TITEN SCREW TO CMU	POST-INSTALLED
	1065#	SIMPSON H10S	(8) 8dx1)* LONG TO TRUSS AND (2) ^x4* SIMPSON TITEN SCREW TO CMU	POST-INSTALLED
	1450#	SIMPSON META12	(7) 10dx12 LONG	3
SINGLE PLY	1520#	SIMPSON HETA12	(7) 10dx12 LONG	
	1810#	SIMPSON HETA16	(9) 10dx12 LONG	46.5
	1985#	(2) SIMPSON META12	(10) 10dx12 LONG	NOTE 1
	2035#	(2) SIMPSON HETA12	(10) 10dx1}* LONG	NOTE 1
SINGLE OR MULTI PLY,	860#	SIMPSON MTSM16 EA TRUSS + SIMPSON HGAM AT 48*O.C.	(7) 10d TO TRUSS AND (4) \$102 SIMPSON TITEN SCREW TO CMU	POST-INSTALLED, MISSIN EMBEDS.
CMU	1175#	SIMPSON HTSM16 EA TRUSS + SIMPSON HGAM AT 48*O.C.	(8) 10d TO TRUSS AND (4) [1/2]* SIMPSON TITEN SCREW TO CMU	POST-INSTALLED, MISSIN- EMBEDS.
NGLE OR MULTI PLY, CONCRETE	860#	SIMPSON MTSM16 EA TRUSS + SIMPSON HGAM AT 48*O.C.	(7) 10d TO TRUSS AND (4) 拉克 SIMPSON TITEN SCREW TO CONCRETE	POST-INSTALLED, MISSIN EMBEDS.
OCE ON MOLTIPLE, CONCRETE	1175#	SIMPSON HTSM16 EA TRUSS + SIMPSON HGAM AT 48"O.C.	(8) 10d TO TRUSS AND (4) \$\frac{1}{2}^2 x1\frac{3}{2}^2 \\ SIMPSON TITEN SCREW TO \\ CONCRETE	POST-INSTALLED, MISSINI EMBEDS.
SINGLE OR MULTI PLY	3330#	SIMPSON MGT	(22) 10dx12* LONG	NOTE 2
	2150#	SIMPSON LGT2	(16) 1Gd SINKERS	POST-INSTALLED, NOTE
DBL PLY	10980#	SIMPSON HGT-2	(16) 10d	NOTE 3
DBL OR TPL PLY.	1900#	(2) SIMPSON META12	(14) 16d	NOTE 1
CMU	2500#	(2) SIMPSON HETA12	(12) 18d	NOTE 1
	2565N	(2) SIMPSON META12	(14) 16d	NOTE 1
OBL OR TPL PLY, CONCRETE	2700W	(2) SIMPSON HETA12	(12) 16d	NOTE 1
	3350#	(2) SIMPSON HHETA12	(14) 16d	NOTE 1
	3285#	SIMPSON LGT3-SDS2.5	(12) SDS [1x2]* LONG	POST-INSTALLED, NOTE 5
TPL PLY	10530#	SIMPSON HGT-3	(16) 10d	NOTE 3
QUAD PLY	9250#	SIMPSON HGT-4	(16) 10d	NOTE 3
	1450#	SIMPSON META12	(6) 16d	
MULTI PLY	1520#	SIMPSON HETA12	(7) 16d	
	1810#	SIMPSON HETA16	(8) 16d	

- FOR (2) CONNECTORS: (A) THE NAILS SHALL NOT BE DRIVEN IN CONFLICT WITH EACH OTHER OR THE SECOND CONNECTOR, AND (B) STRAPS SHALL NOT OVERLAP THE
- AND COMMISSION.

 AND CO

13. WALL SECTION NOTES

- RESIDENTIAL.


 13.5 INSTALLATION OF FLASHING SHALL MEET THE REQUIREMENTS OF SECTION RY03.4 OF THE FBC 7TH EDITION (2020) RESIDENTIAL.

14. WATER PROOFING NOTES

14.1 ALL WATER-PROOFING AND MOISTURE PROTECTION IS THE RESPONSIBILITY OF THE BUILDER.

POST UPLIFT ANCHORS - MASONRY/CONCRETE POST ANCHORS TO MASONRY OR CONCRETE SHALL SE AS FOLLOWS (REFER TO SIMPSION AZOS CATALOS IN-ZIZO) OTHER REMAINS OF CONNECTIONS MAY SES JUSTITUTED IF BOTH UP-LIFT AND LATERAL LOAD CAPACITIES ARE EQUAL OR GREATER THAN CONNECTIONS SPECIFIED FASTENER TO POST FOR NOMINAL UPLIFT MINIMUM POST THICKNESS ANCHOR BOLT DIAMETER 1310# SIMPSON LTT19 (8) 10dx14* LONG NAILS 2 2 OR 2 1350# SIMPSON LTTIST (18) 10dx11 LONG NAILS 3610# SIMPSON HTT4 (18) 10dx11 LONG NAILS 4350# SIMPSON HTTS (26) 10dx11 LONG NAILS 2405# SIMPSON HDS (2) P DIAM STUD BOLTS FOR 3955# SIMPSON HTT16 (18) 16dx21 LONG NAILS 4235# SIMPSON HTTA (18) 16dx2/1 LONG NAILS SOCOU SIMPSON UTTE S HAM SWO I SEVARE (BC) 1815# SIMPSON HDS 121 P DIAM STUD BOLTS 4165# SIMPSON HTT2 (32) 10d NAILS 4670# (26) 10d NAILS SIMPSON HTTS (3) P DIAM STUD BOLTS FOR 1 (2) P DIAM STUD BOLTS (3) F DIAM STUD BOLTS (OR 1 (OR 1 SIMPSON HD12

- A* DIAMETER A307 ALL THREAD SET IN A* DIAMETER HOLE W/ SIMPSON SET EPDLY VIAN EMBED 6*
- DOMETER ASSA ALL THREAD SET IN § DIAMETER HOLE WI SIMPSON SET EPOXY, MIN EMBELD 8°
 ↑ DIAMETER ASSA ALL THREAD SET IN § DIAMETER HOLE WI SIMPSON SET OR EQUAL, MIN EMBED 8°
 ↑ DIAMETER ASSA ALL THREAD SET IN § DIAMETER HOLE WI SIMPSON SET OR EQUAL, MIN EMBED 9°
 ↑ DIAMETER ASSA ALL THREAD SET IN § DIAMETER HOLE WI SIMPSON SET OR EQUAL, MIN EMBED 9°.

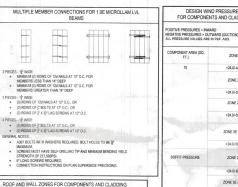



DESIGN WIND PRESSURES FOR COMPONENTS AND CLADDING

> +24.01-43.2 ZONE 2E

TO THE BEST OF MY KNOWLEDGE, THE PLANS AND SPECIFICATIONS FOR THIS RESIDENCE COMPLY WITH THE APPLICABLE STRUCTURAL PROVISIONS OF THE






YOUNG


VICKI SKIDMORE LONGBOAT KEY, FL 34228 Home for: ustom I NY & DRIVE, ACL ANTHON BAYVIEW [


> /SPEC NOTES/ - 0" STRUCTURAL


REVISIONS BY DATE JDY 06.09.2021


S4

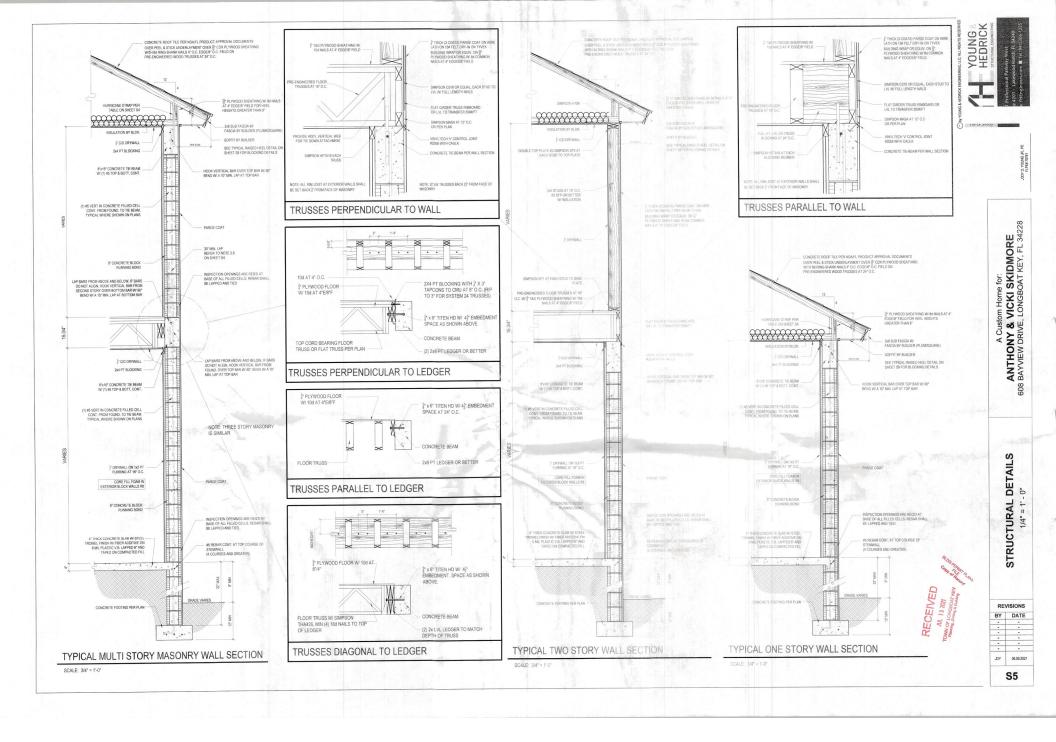

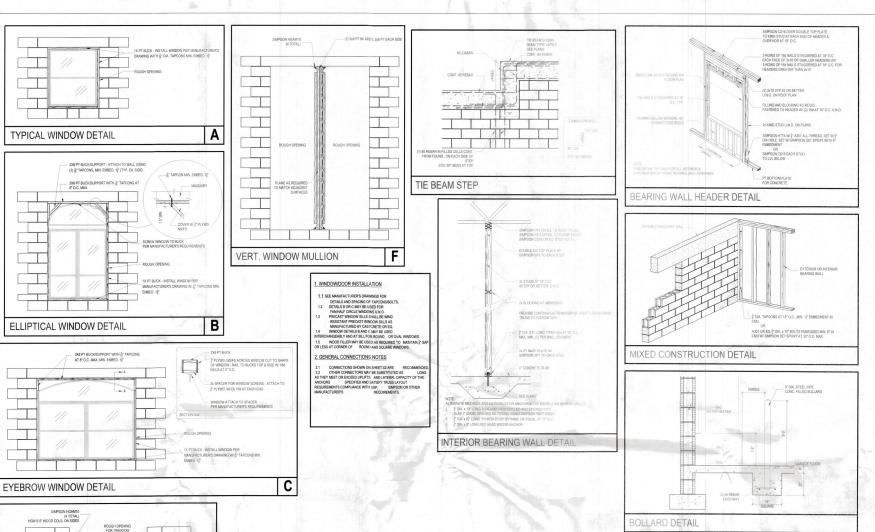

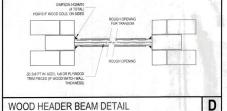

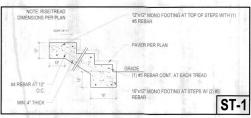

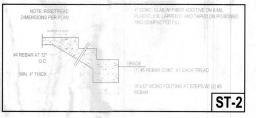



REVISIONS BY DATE JDY 06.09.2021

STRUCTURAL DETAILS 1/4" = 1' - 0"

A Custom Home for:


ANTHONY & VICK! SKIDMORE


608 BAYVIEW DRIVE, LONGBOAT KEY, FL 34228


YOUNG REDRICK


S6




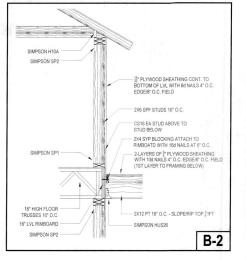


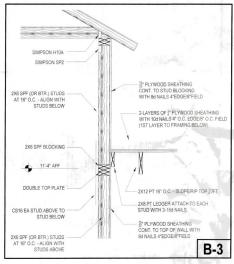


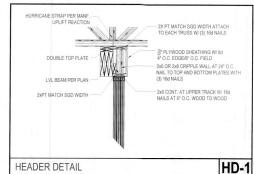


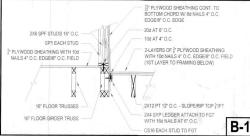


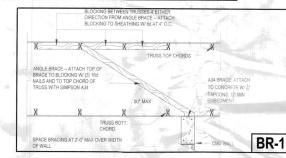

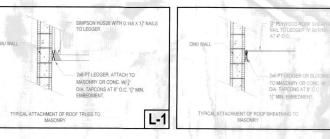

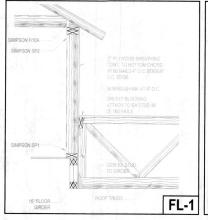

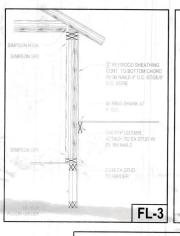

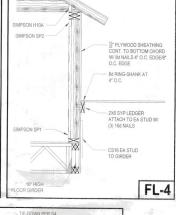

150 PLYWOOD SHEATHING CONT. TO BOTTOM CHORD

W/ 8d NAILS 4" O.C. EDGE/8"

8d RING-SHANK AT 4" O.C. - 2X6 SYP BLOCKING ATTACH TO EA STUD W/


(3) 16d NAILS


CS16 EA STUD TO GIRDER

FL-2


ROOF TRUSS ..


 $\widetilde{\mathbb{W}}$

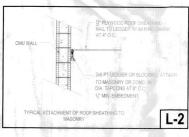

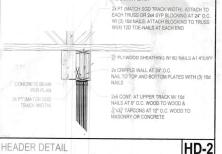

19 2021 LONGBOAT

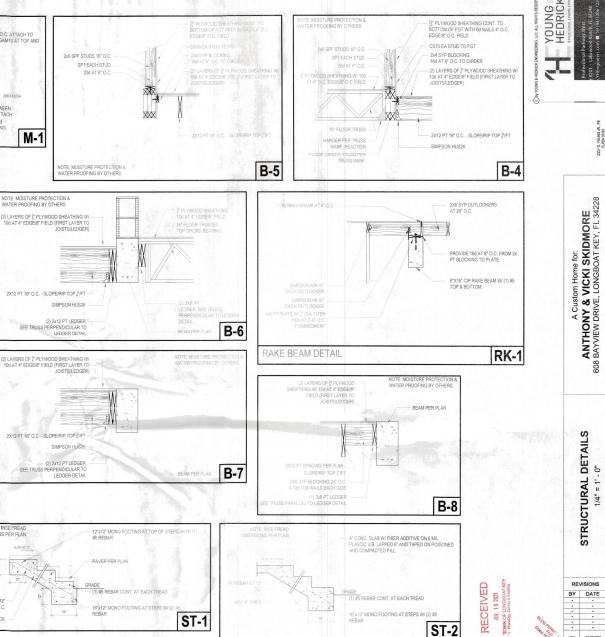

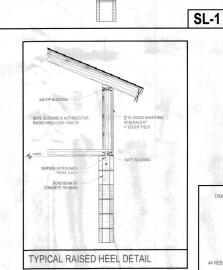


CMU WALL

HOOK MIN. 8" HOOK EXTENSION

ADD'L. NO. 5 REBAR CONT. AT

8"X16" BEAM WITH (2) NO. 5 TOP

AND BOTTOM NO. 3 TIES 6" O.C.

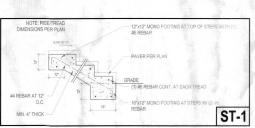

MONO TRUSSES AT 24" O.C. ATTACH TO

NOTE: PROVIDE 2X6 PT BLOCKING RETWEEN TRUSSES UNDER ROOF SHEATHING, ATTACH

TO CMU WITH 2" X 3" TAPCONS 8" O.C. 8d


INTO TOP OF LEDGER

8" CONCRETE SLAB WITH #5 REBAR AT 12" O.C. E.W. AT CENTER, SLOPE TOP 1"/FT

PROVIDE NO.5 REBAR AROUND PERIMETER EDGE

WALL WITH SIMPSON HGAM10 AT TOP AND

M-1

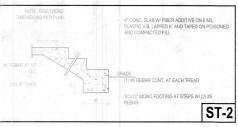

06.09.2021 S8